
ABBREVIATIONS

	ATIONS		
ALT	ALTERNATE		
BLDG	BUILDING		
BM	BEAM		NORTH ARROW
BSMT	BASEMENT	-	
CLG	CEILING		
CMU	CONCRETE MASONRY UNIT		CALLOUT HEAD
		1 A101	O/ (LLOOT TIL/ (D
COL	COLUMN		
CONC	CONCRETE		
CONT	CONTINUOIS	Ę	CENTER LINE
DIA	DIAMETER		
DIM	DIMENSION		
DN	DOWN		DOOR TAG
ELEC	ELECTRIC	101	BOOKING
ELEV	ELEVATOR, ELEVATION		
EQ	EQUAL		
EXIST	EXISTING	1 Ref	ELEVATION MARKER
EXP	EXPANSION	1 A101 TO	
EXT	EXTERIOR	1 Ref	
FD	FLOOR DRAIN		
FE	FIRE EXTRINGUISHER		
FLR	FLOOR		GRID HEAD
FT	FOOR, FEET	0	
GA	GUAGE		
GWB	GYPSUM WALL BOARD		
		_ Name _	LEVEL HEAD
GYP	GYPSUM	Elevation —	
HT	HEIGHT		
LOC	LOCATION		ROOM TAG
MAS	MASONRY	Room name	NOOM IAO
MECH	MECHANICAL	101	
NOM	NOMINAL		
NTS	NOT TO SCALE		
OC	ON CENTER	SIM	SECTION ARROW
PERIM	PERIMETER	A101	
PERP	PERPENDICULAR		
PL	PROPERTY LINE		
PLWD	PLYWOOD	11	WALL TAG
PRCAST	PRECAST	1i	
R	RADIUS		
REINF	REINFORCED		WINDOW TAG
RM	ROOM	1t	VVII VD O VV 17 VO
SQ	SQUARE		
SQ IN	SQUARE INCH		
THK	THICK	SYMBOL KEY	
TYP	TYPICAL	1/2" = 1'-0"	
W/			
V V /	WITH		

LOCATION MAP

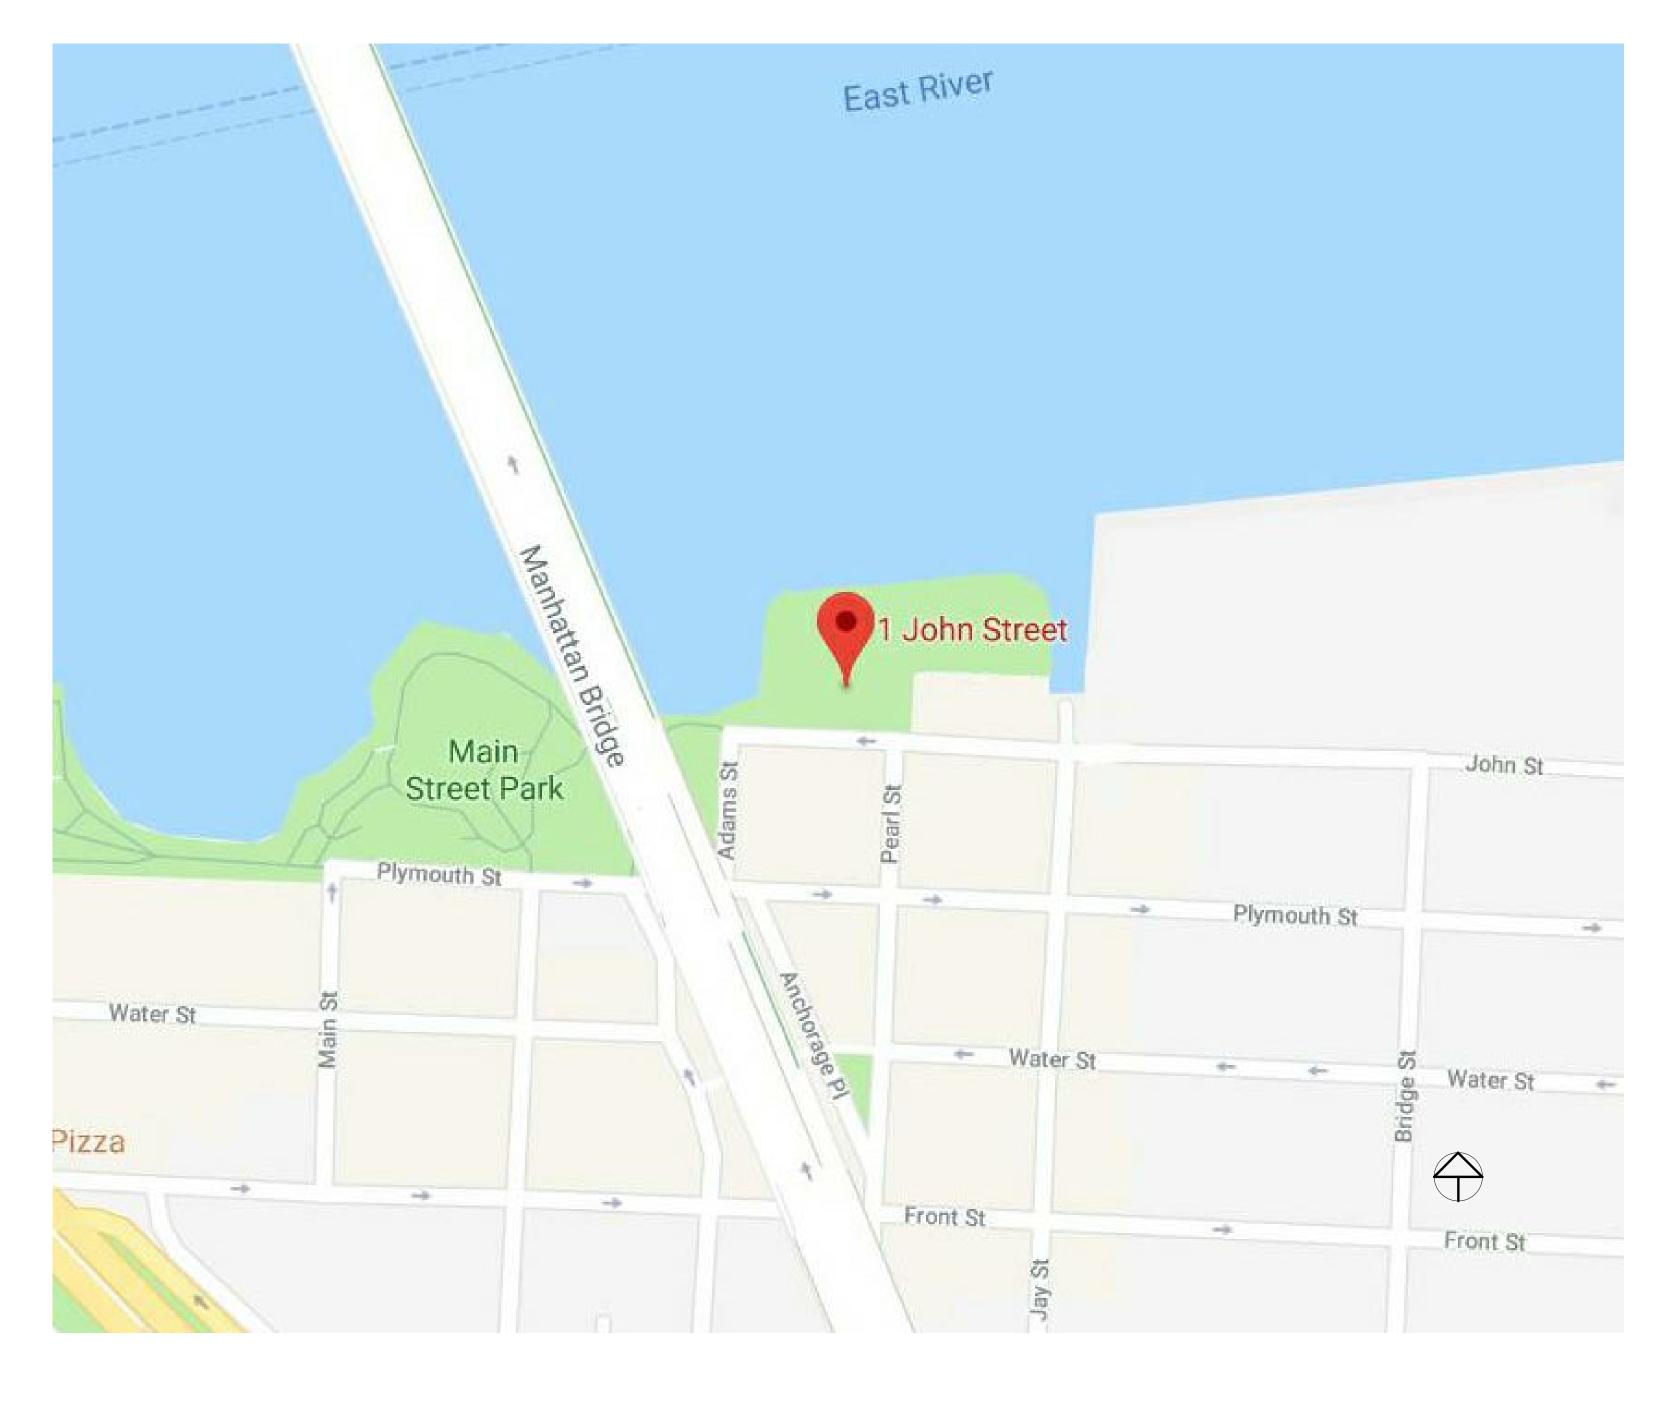

Sheet List		
Sheet Number	Sheet Name SCALE	DESCRIPTION
G-100.000	COVER SHEET	PROJECT NAME AND ADRESS, RENDERING,ABBREVIATIONS,SYMBOLS LEGEND AND DRAWING LIST
G-102.000	SITE PLAN	SITE PLAN,ADRESS,BLOCK,LOT,AND ZONING INFO
G-101.00	ADA DIAGRAMS	ADA DIAGRAMS-(2) DOOR CLERANCES,(1) CORRIDOR WIDTHS,BATHROOM REQUIREMENTS (1 TOILET STALL,1 LAV)
S-100.00	FOUNDATION FRAMING PLAN	GRIDS, GRID DIMENSIONS, FOUNDATION TAGS, COLUMN TAGS
S-101.00	GROUND FLOOR TYPICAL FRAMING PLAN	GRIDS, GRID DIMENSIONS, COLUMN TAGS
S-102.00	3D VIEW OF CONCRETE FRAME	(2) 3D VIEWS OF CONCRETE FRAME, INCLUDING FOUNDATIONS, SLABS, COLUMNS, SHEAR WALLS
A-100.00	GROUND FLOOR PLAN	GRIDS, GRID DIMENSIONS, LAYOUT DIMENSIOSN, ENLARGED PLAN, SECTION AND ELEVATION CALLOUTS, ROOM AND WALL TAGS, PARTITION TYPE TAGS
A-101.00	ENLARGED CORE PLANS-GROUND/TYP FLOOR	GRIDS, GRID DIMENSIONS, LAYOUT DIMENSIONS, WALL TAGS, ROOM DIMENSIONS-BATHROOM AND ELEV CORES
A-102.00	FINISH PLAN-GROUND/TYP FLOOR	GRIDS, GRID DIMENSIONS, FINISH TAGS, ROOM TAGS, FINISH LEGEND, FINISH SCHEDULE
A-200.00	REFLECTED CELING PLANS-GROUND/TYP FLOOR	GRIDS,GRID DIMENSIONS,CEILING LAYOUT, LIGHTING, SPRINKLER HEADS, SUPPLY AND ERTURN DIFFUSERS
A-300.00	OVERALL ELEVATIONS NORTH AND WEST	GRIDS,GRID DIMENSIONS, LEVELS, LEVEL DIMENSIONS, SOLAR STUDY
A-301.00	OVERALL ELEVATIONS SOUTH AND EAST	GRIDS,GRID DIMENSIONS, LEVELS, LEVEL DIMENSIONS, SOLAR STUDY
A-400.00	3D EXPLODED BUILDING DIAGRAM	EXPLODED AXON SHOWING CLADDING,STRUCTURE AND INTERIORS
A-500.00	ENLARGED CURTAIN WALL ELEVATIO-WALL SECTION	ENLARGED ELEVATION, WALL SECTION+ISOMETRIC AT CURTAIN WALL
A-501.00	CURTAIN WALL DETAILS	AT BASE,FLOOR,ROOF:(2) 3D DETAILS(INTERIOR AND EXTERIOR SIDES),(1) 2D PLAN DETAIL,(1)2D PLAN DETAIL,(1)2D SECTION DETAIL, INSTALLATION SEQUENCE AT FLOOR
A-502.00	ENLARGED PRE CAST CONC. ELEVATION + WALL SECTION	ENLARGED ELEVATION, WALL SECTION +ISOMETRIC AT PRECAST CONCRETE WALL
A-503.00	PRECAST CONCRETE DETAILS	AT BASE,FLOOR,ROOF:(2) 3D DETAILS(INTERIOR AND EXTERIOR SIDES),(1) 2D PLAN DETAIL,(1)2D PLAN DETAIL,(1)2D SECTION DETAIL, INSTALLATION SEQUENCE AT FLOOR
A-504.00	CURTAIN WALL + PRECAST CONCRETE ANALYSIS	BARRIER LAYER ANALYSIS
A-505.00	PARTITION TYPES	(4) PARTATION TYPE DETAILS, DIMENSIONS AND NOTES
A-506.00	ENLARGED STAIR PLANS AND SECTIONS	(1) PLAN OF EACH EGRESS STAIR,(1)SECTION THROUGH EACH STAIR-GRIDS,GRID DIMENSIONS AND NOTES
A-600.00	OUTLINE SPECIFICATIONS	
S-101.01	OFFICE TYPICAL FRAMING PLAN	
A-101.10	ENLARGED CORE PLANS GROUND/TYP FLOOR	
A-100.01	THIRD FLOOR/TYP OFFICE FLOOR PLAN	



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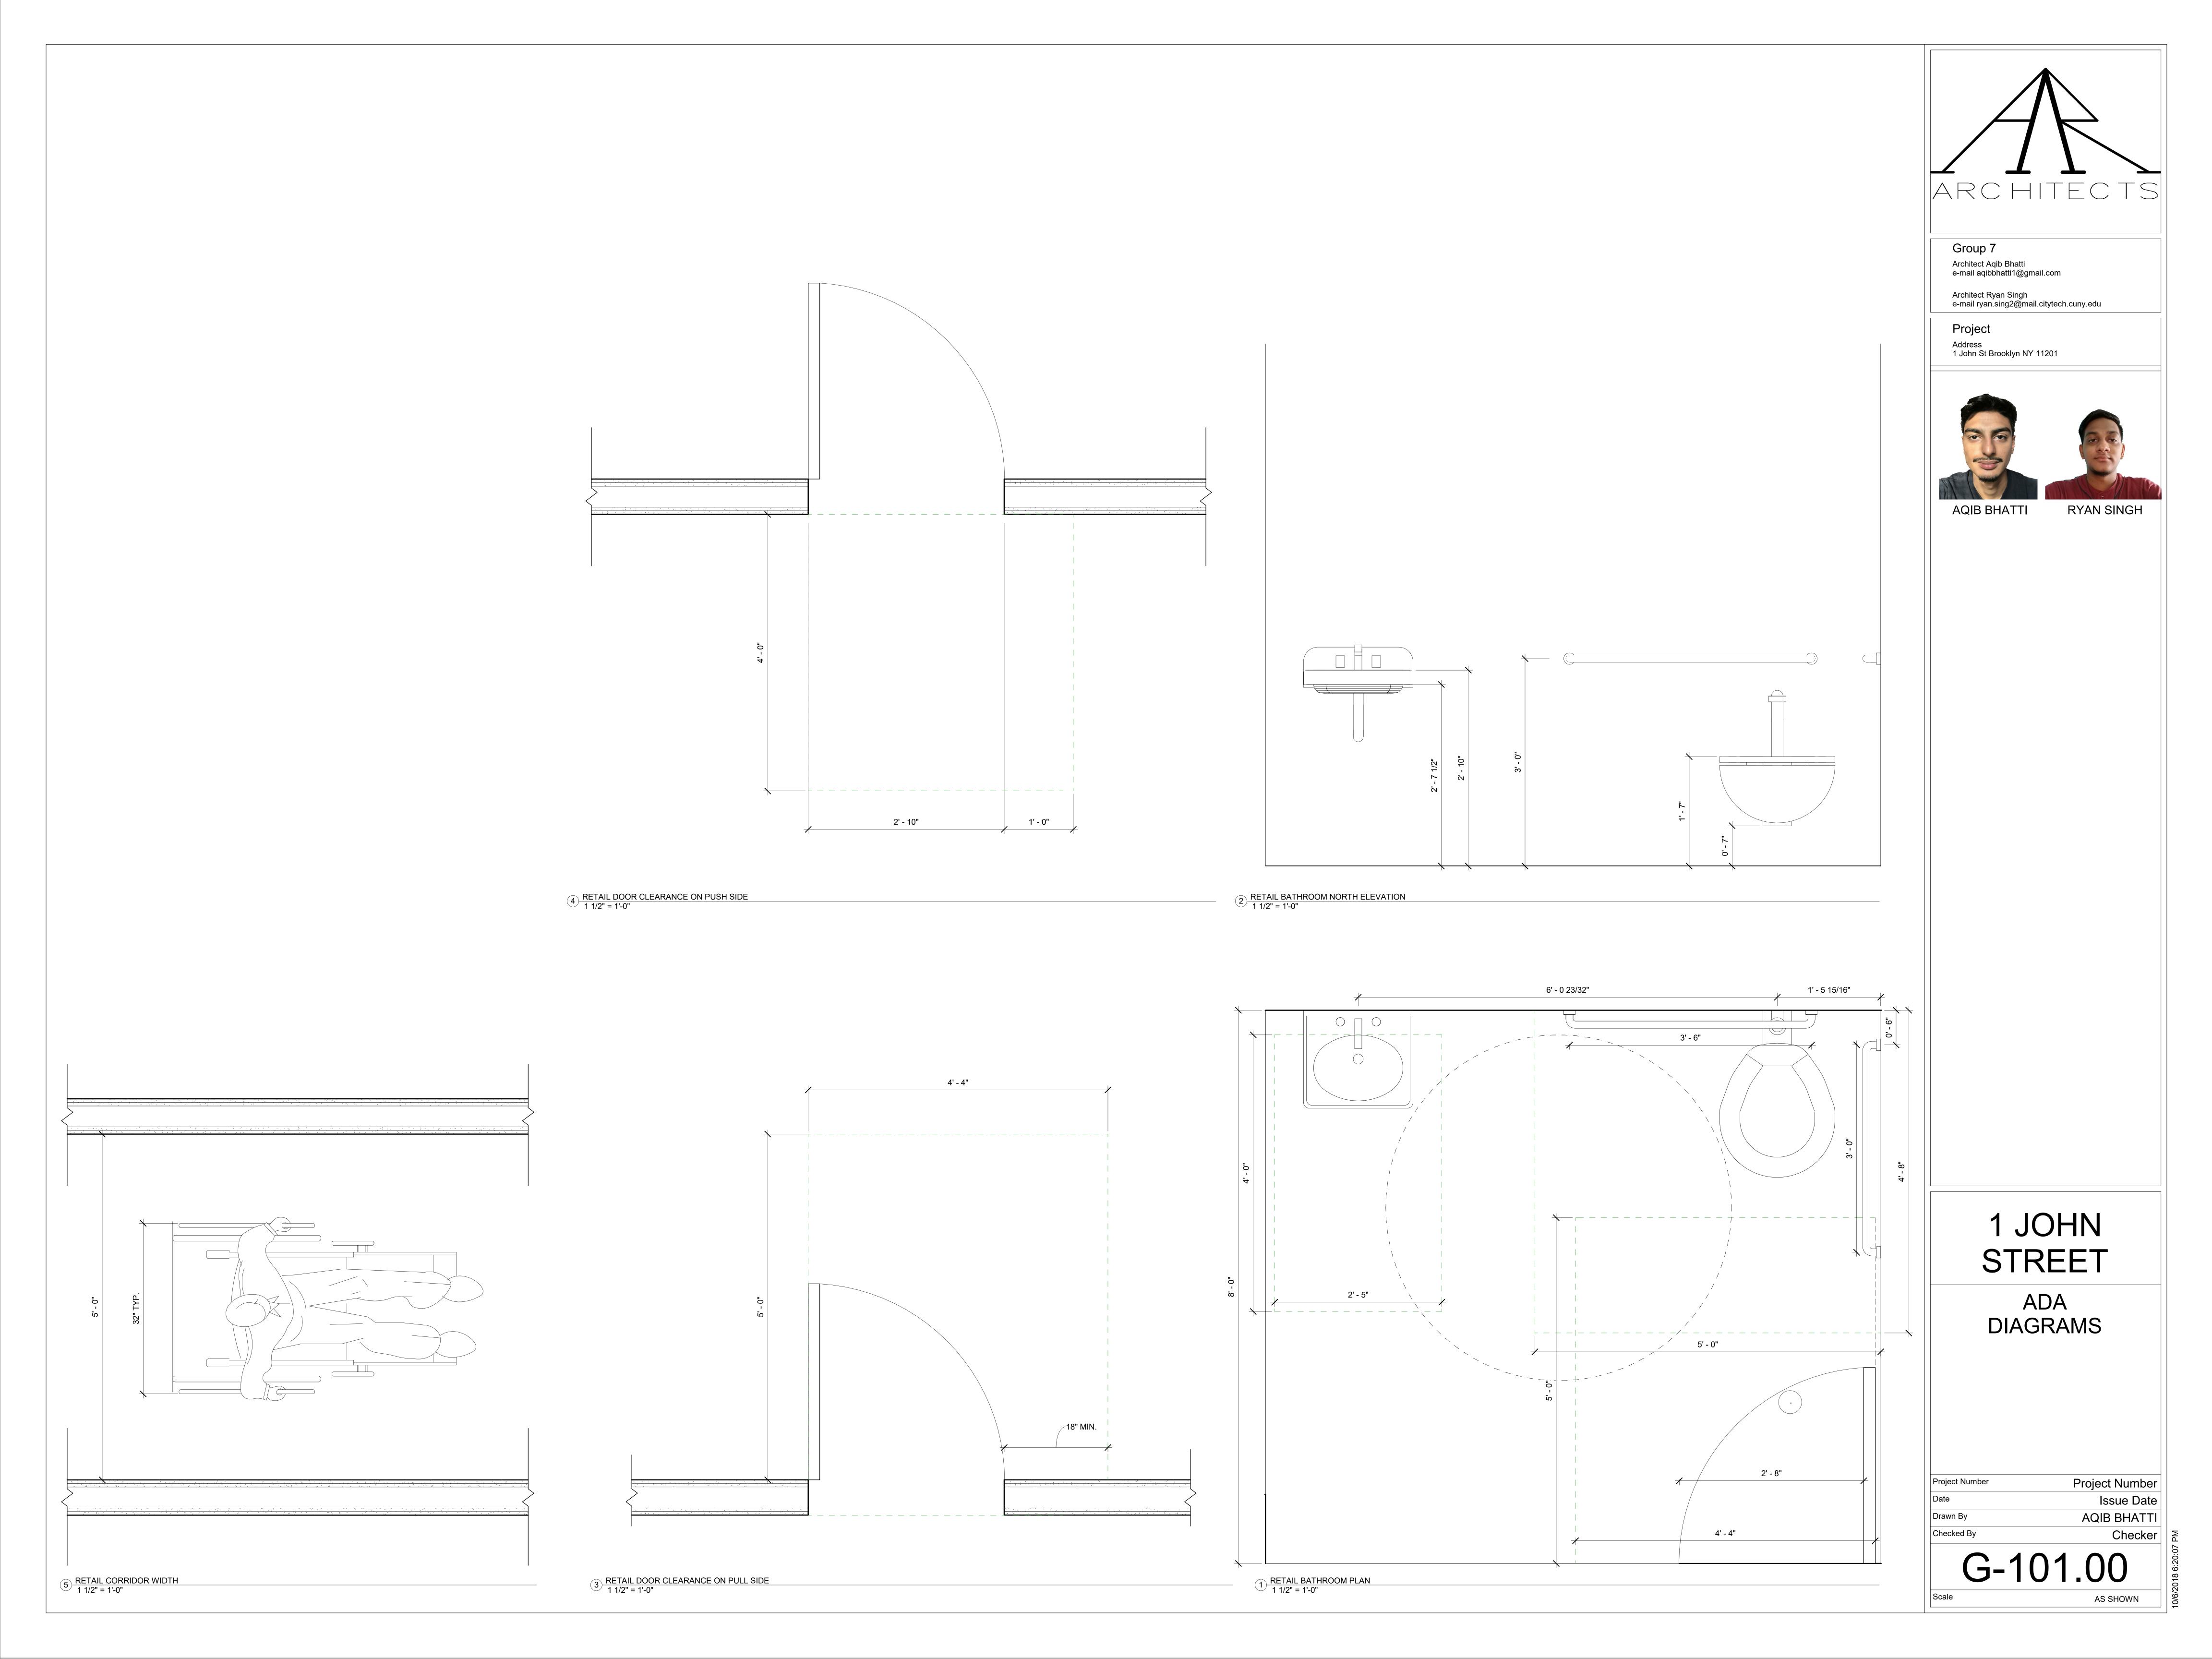



1 JOHN STREET


> COVER SHEET

oject Number	Project Number
te	Issue Date
awn By	AQIB BHATTI
acked By	Chaalcar

G-100.000



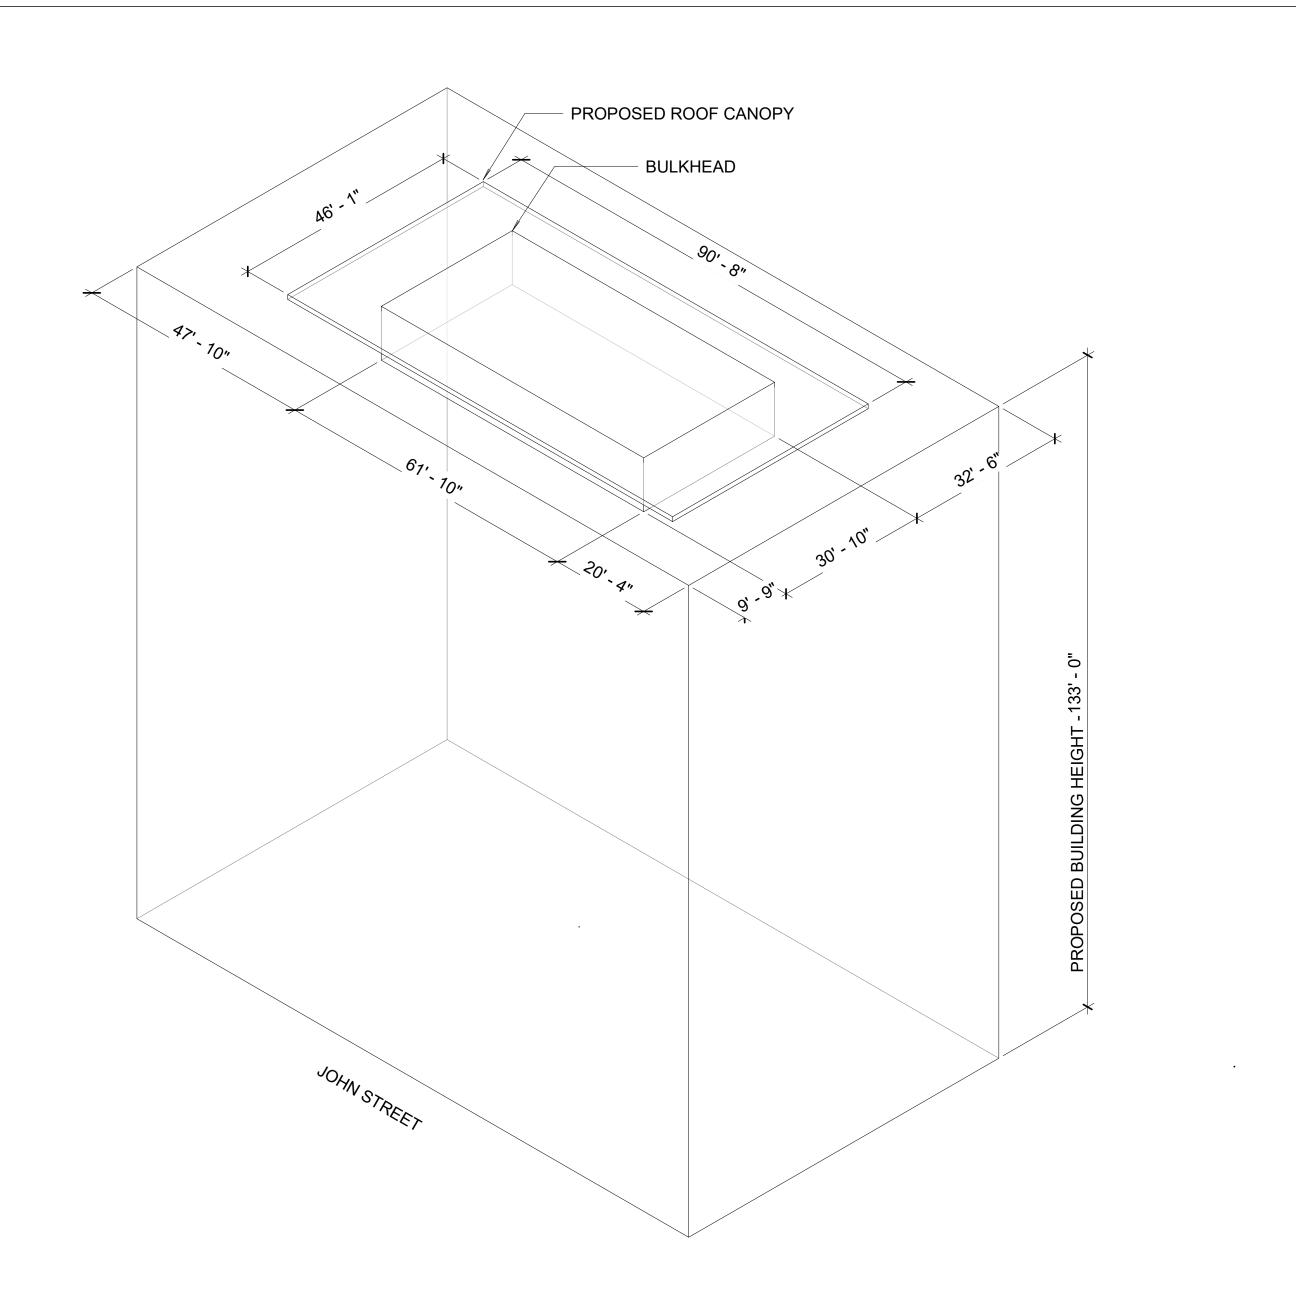

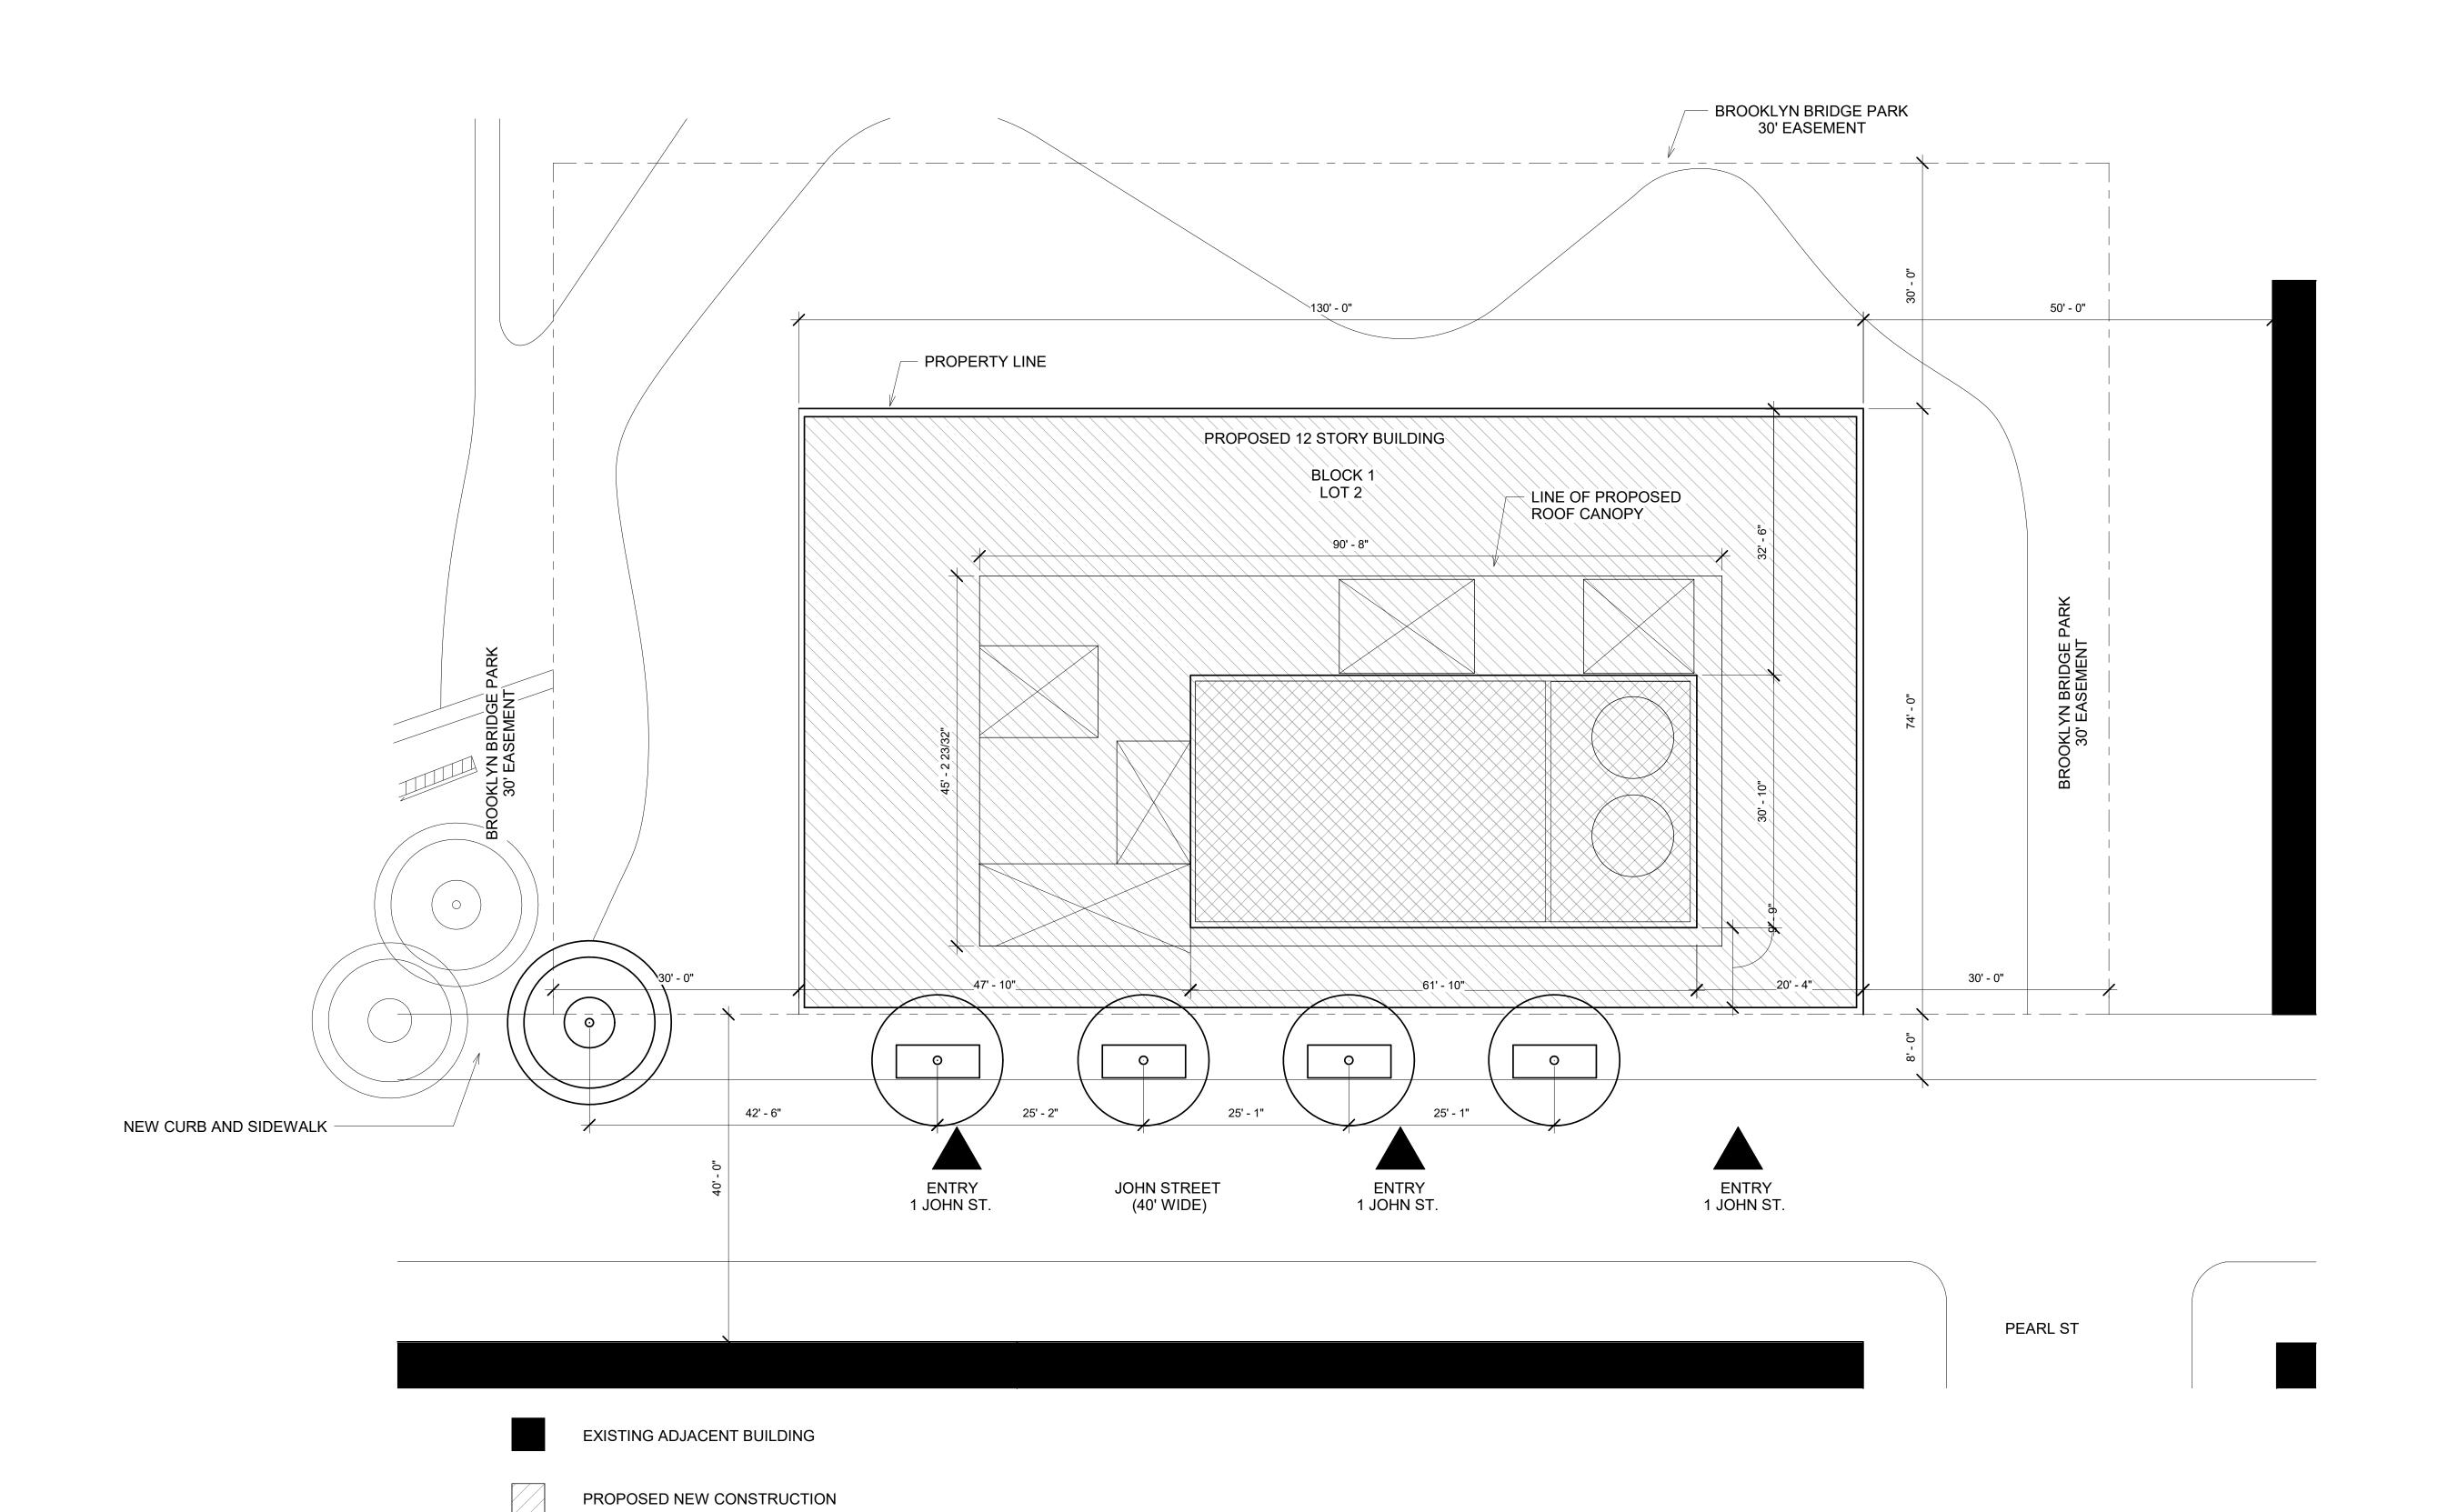

1 John St Block/Lot: Block 1,Lot 2 **Zoning District:** MX-2 **Underlying Districts:** N/A Lot Area: 9,617 s.f 9,617 s.f Lot Coverage

Zoning Regulations:	
Maximum Lot Coverage % per Z.R. 123-64	N/A
Proposed Lot Coverage	100%
Required Front Yard per Z.R. 123-652	N/A

Proposed:	0'
Required Side Yard per Z.R. 123-652	N/A
Proposed:	0'
	

Required Rear Yard per Z.R. 23-541	N/A
Proposed:	0'
Base Height (John ST):	N/A

	Proposed:	133'
	Max Builiding Height	N/A
_	Proposed:	133'

Base Far	N/A
per Z.R. 123-64/23-952	N/A
Gross Residential Floor Area	108,496 sf
Gross Commercial Floor Area	11,371 sf
Proposed Total Gross Floor Area	119,840 sf

Street Tree Analysis	John St
Street Frontage	130'-0"
Required Street Trees per Z.R. 23-03/26-41	N/A
Trees to be planted on site	5
Trees to be planted off site	0
No. of trees where payment is to be made to Parks Dept.	0


JOHN ST BASE PLAN CALCULATIONS:

BASE PLANE=DESIGN FLOOD ELEVATION=NAVD88 ELEV. +14'



Group 7 Architect Aqib Bhatti e-mail aqibbhatti1@gmail.com Architect Ryan Singh e-mail ryan.sing2@mail.citytech.cuny.edu

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RYAN SINGH

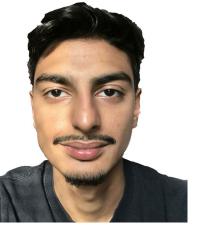AQIB BHATTI

1 JOHN STREET

> SITE PLAN

Project Number Project Number Issue Date AQIB BHATTI, RYAN SINGH


Checker

1 SITE PLAN 3/32" = 1'-0"

PROPOSED BULKHEAD

2 PROPOSED BUILDING ENVELOPE

AS SHOWN

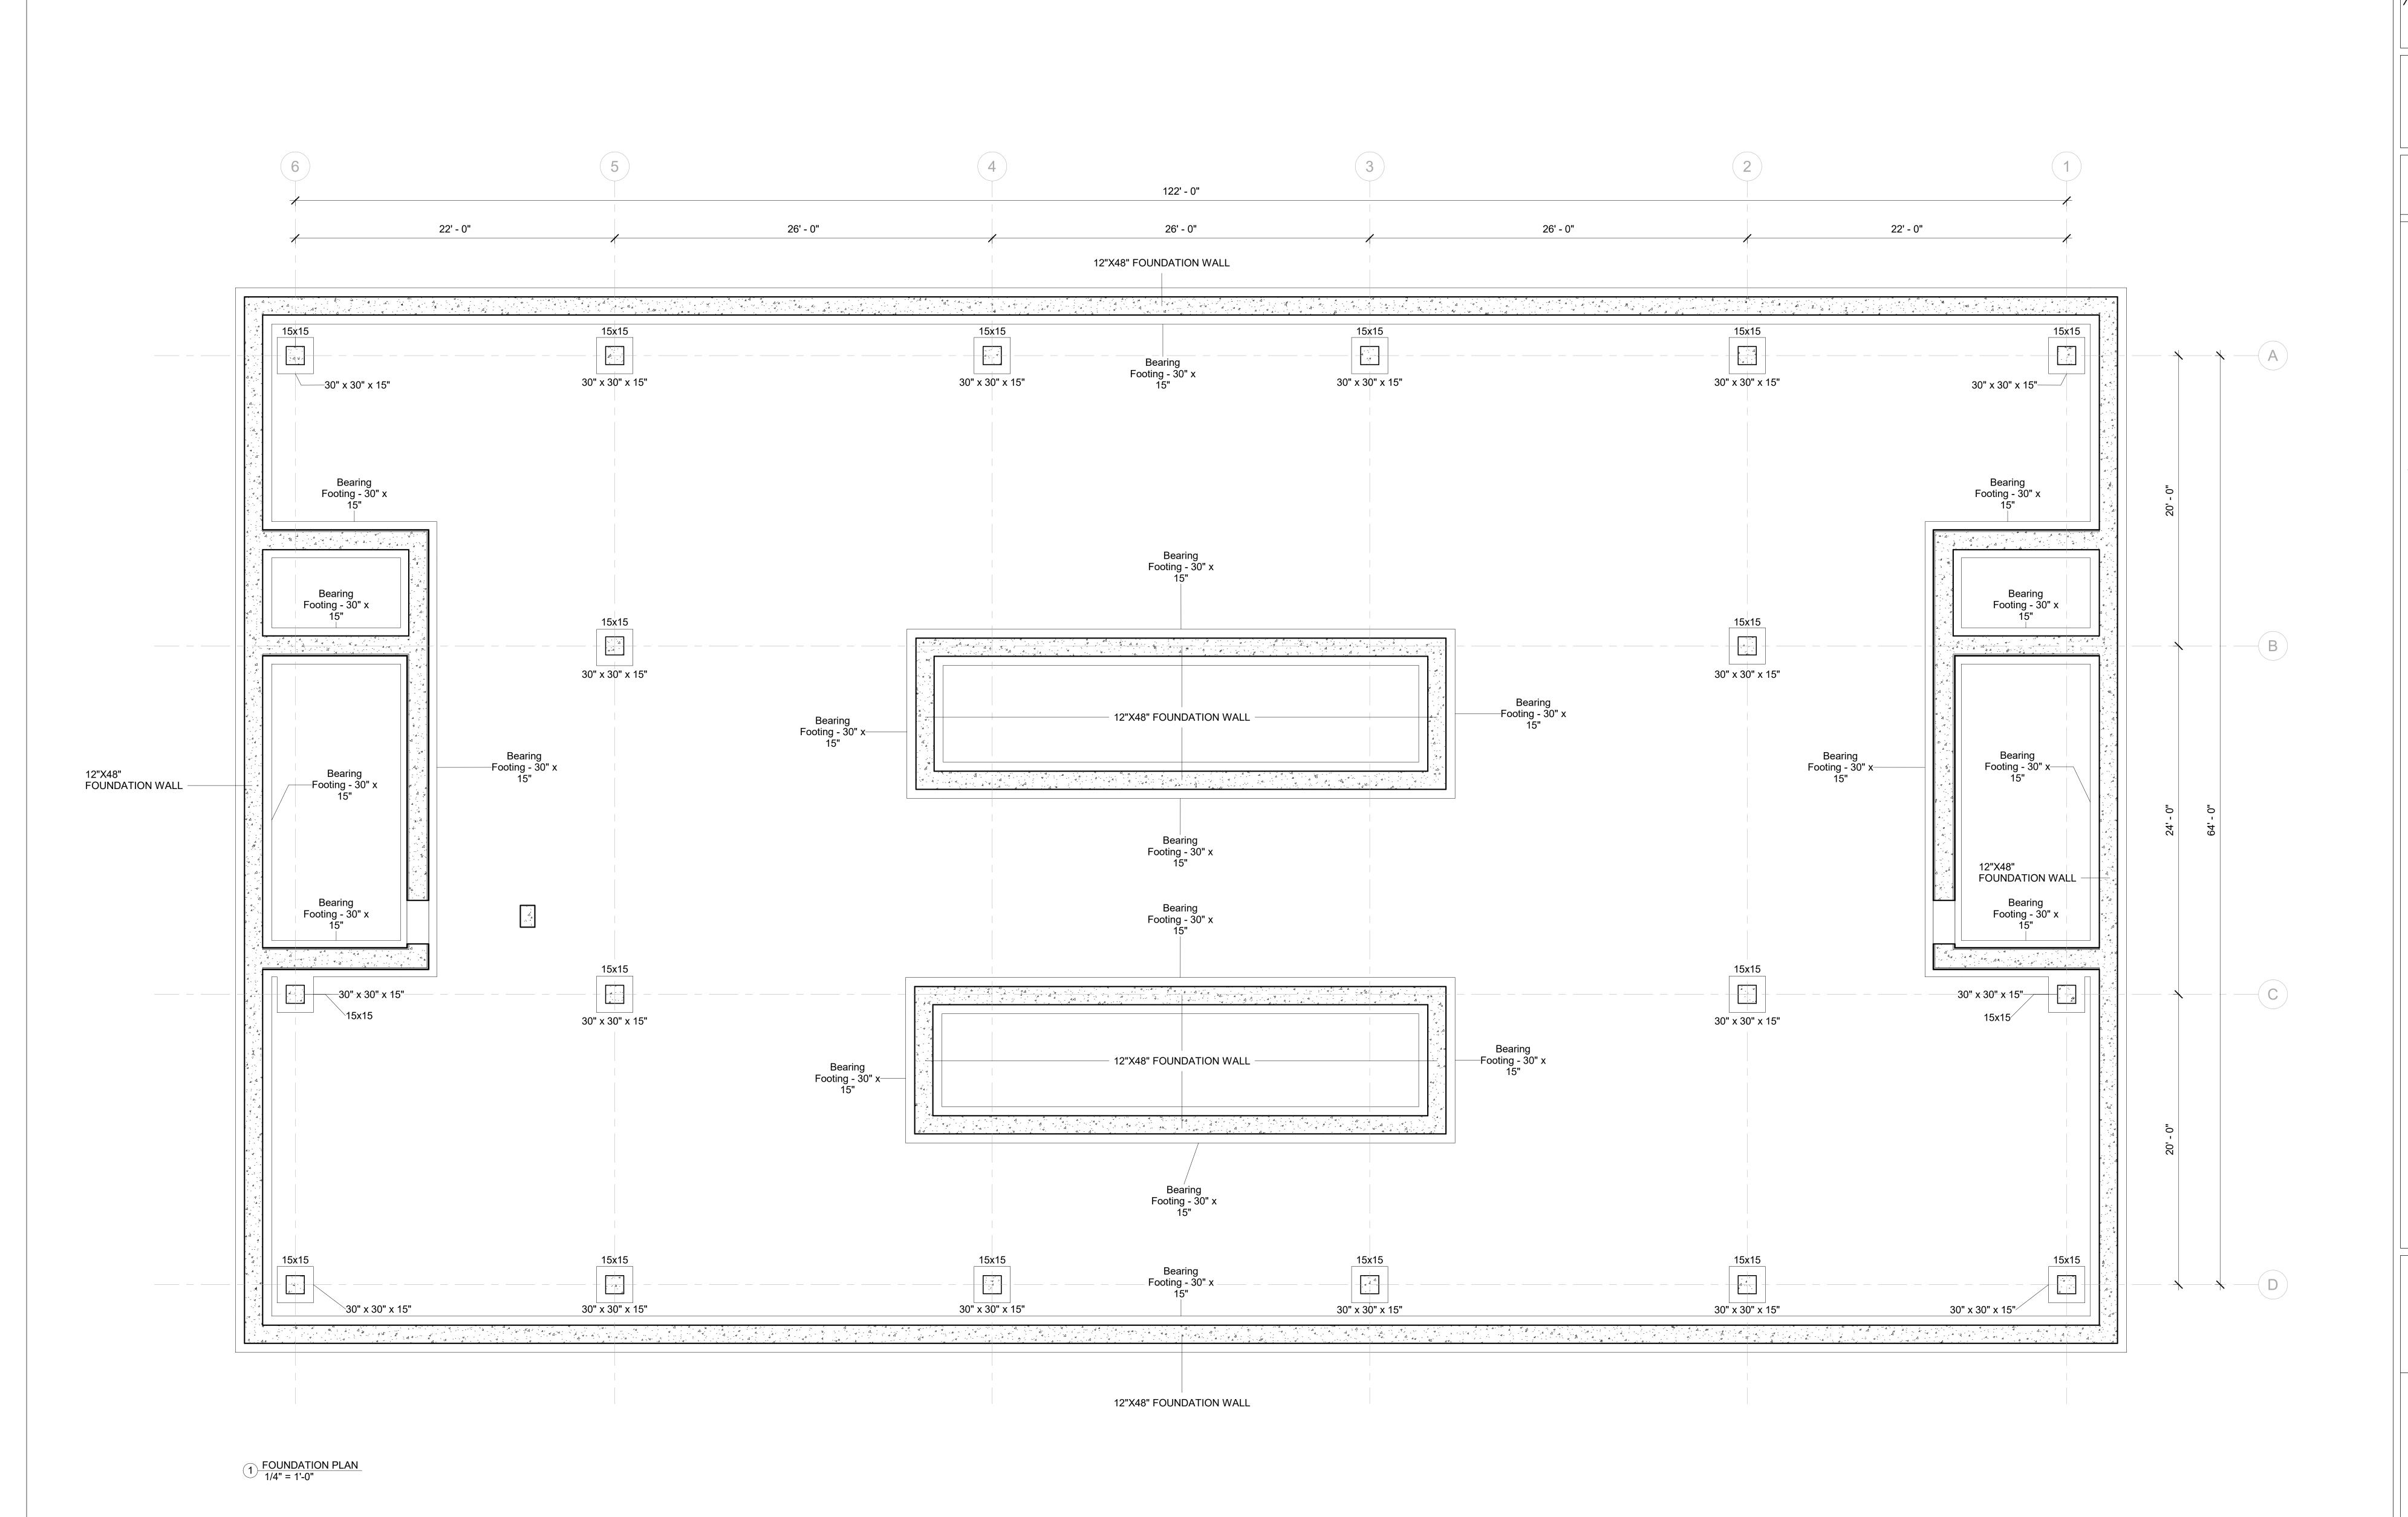




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RYAN SINGH

AQIB BHATTI

NOTE: CONCRETE COLUMNS, ISOLATED FOOTINGS, SPREAD FOOTINGS AND BEARINGS WALLS WILL BE MADE FROM 11,000 PSI CONCRET
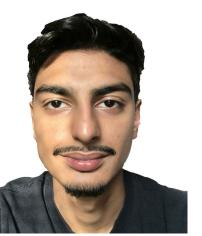
> 1 JOHN STREET


FOUNDATION FRAMING PLAN

Project Number

te Issue Date

AQIB BHATTI, RYAN SINGH
Checker

S-100.00

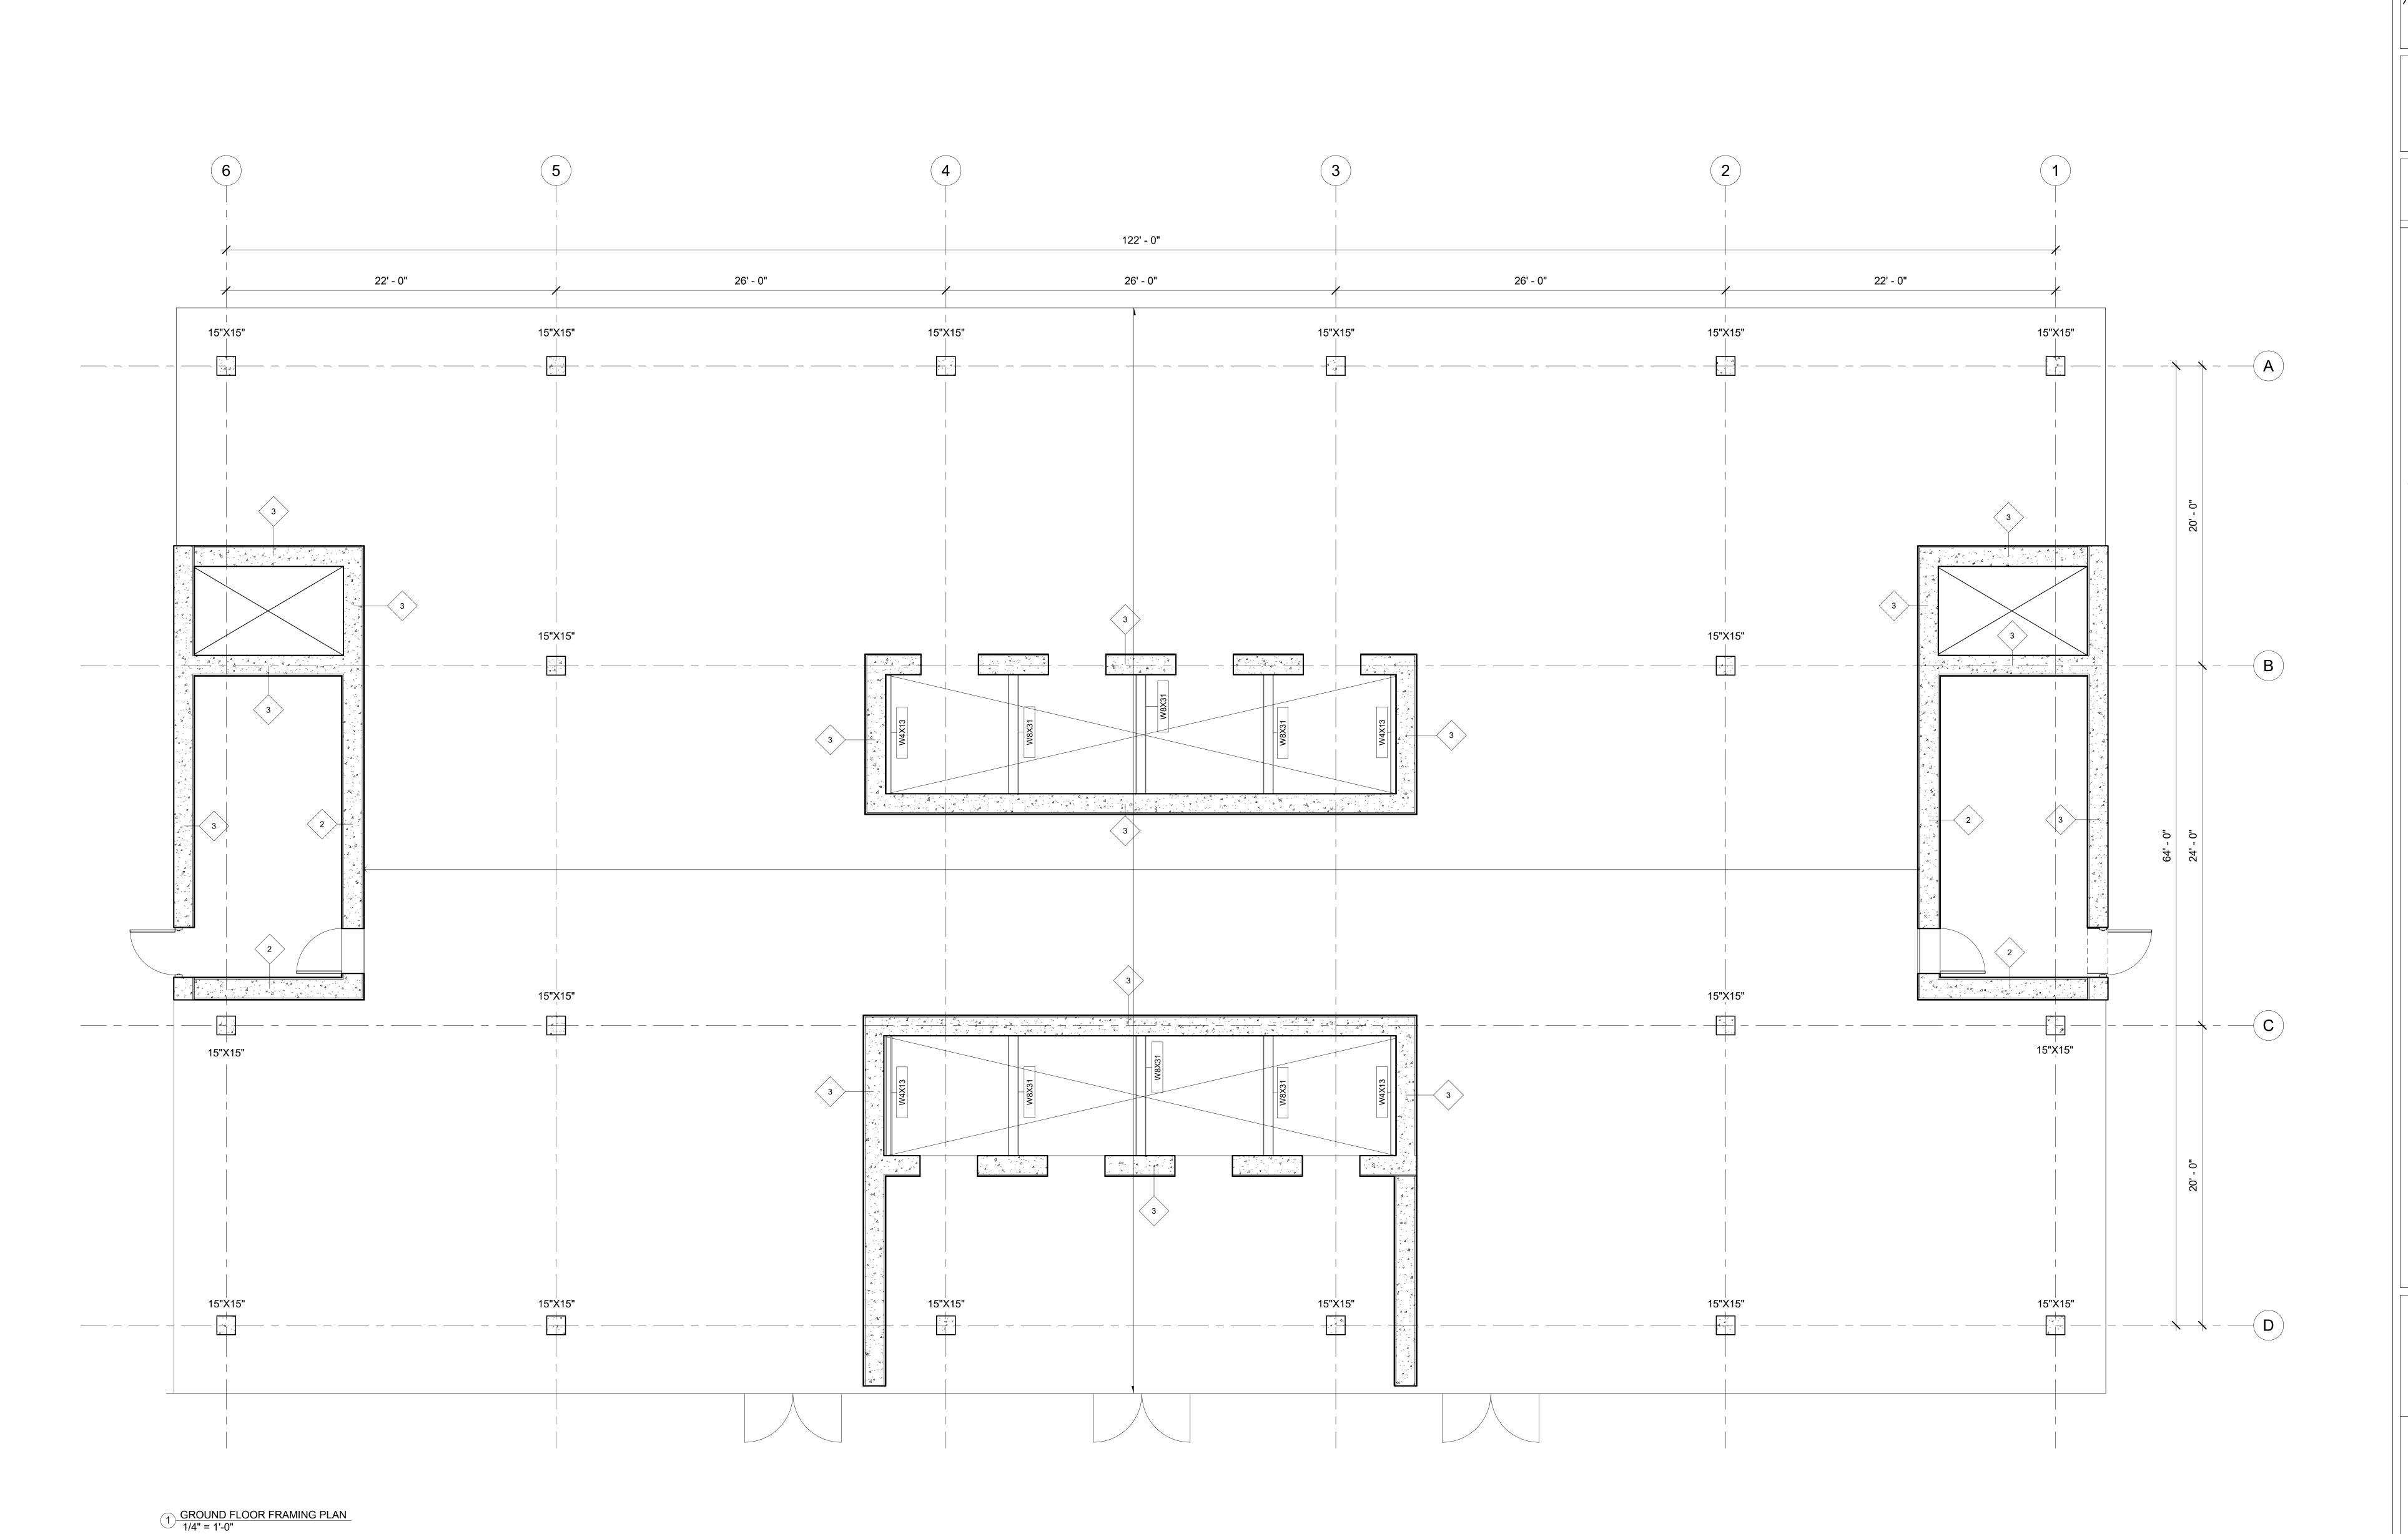



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AQIB BHATTI

RYAN SINGH

NOTE: CONCRETE COLUMNS, ISOLATED FOOTINGS, SPREAD FOOTINGS AND BEARINGS WALLS WILL BE MADE FROM 11,000 PSI CONCRET


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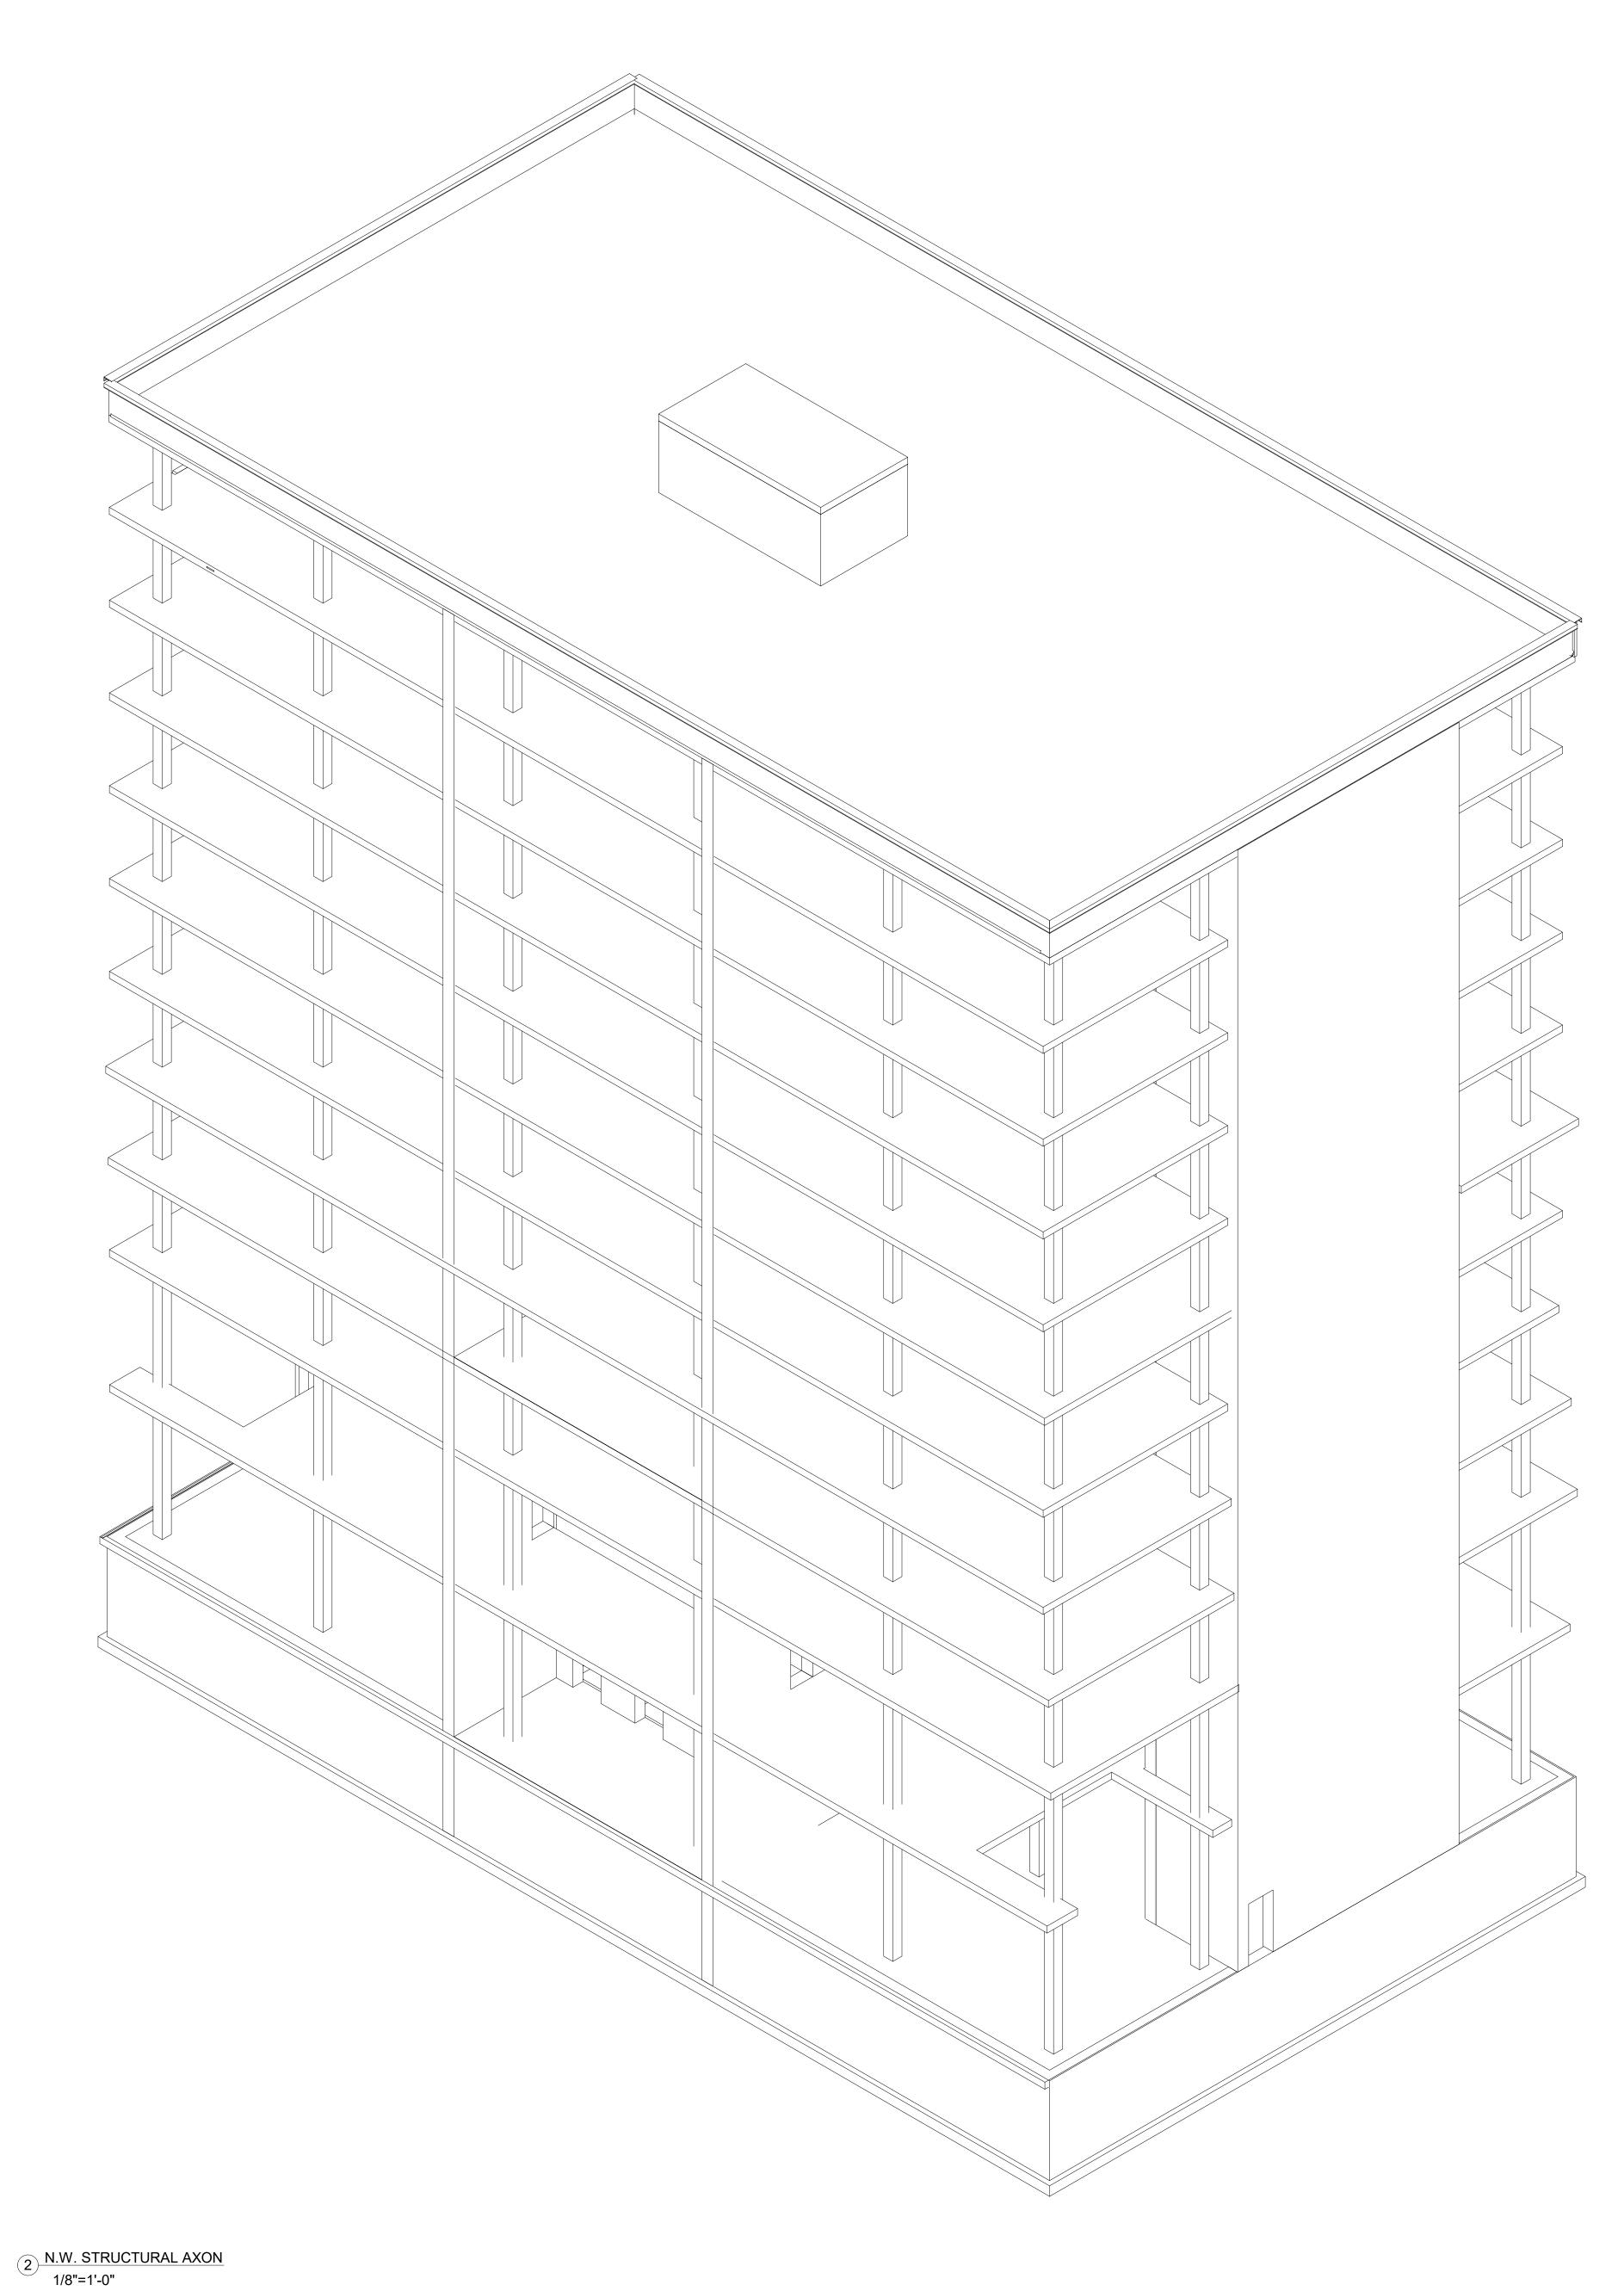
GROUND FLOOR **TYPICAL** FRAMING PLAN


Project Number	Project Number
Date	Issue Date
Drawn By	AQIB BHATTI
Checked By	Checker

S-101.00

1/4"=1'0"




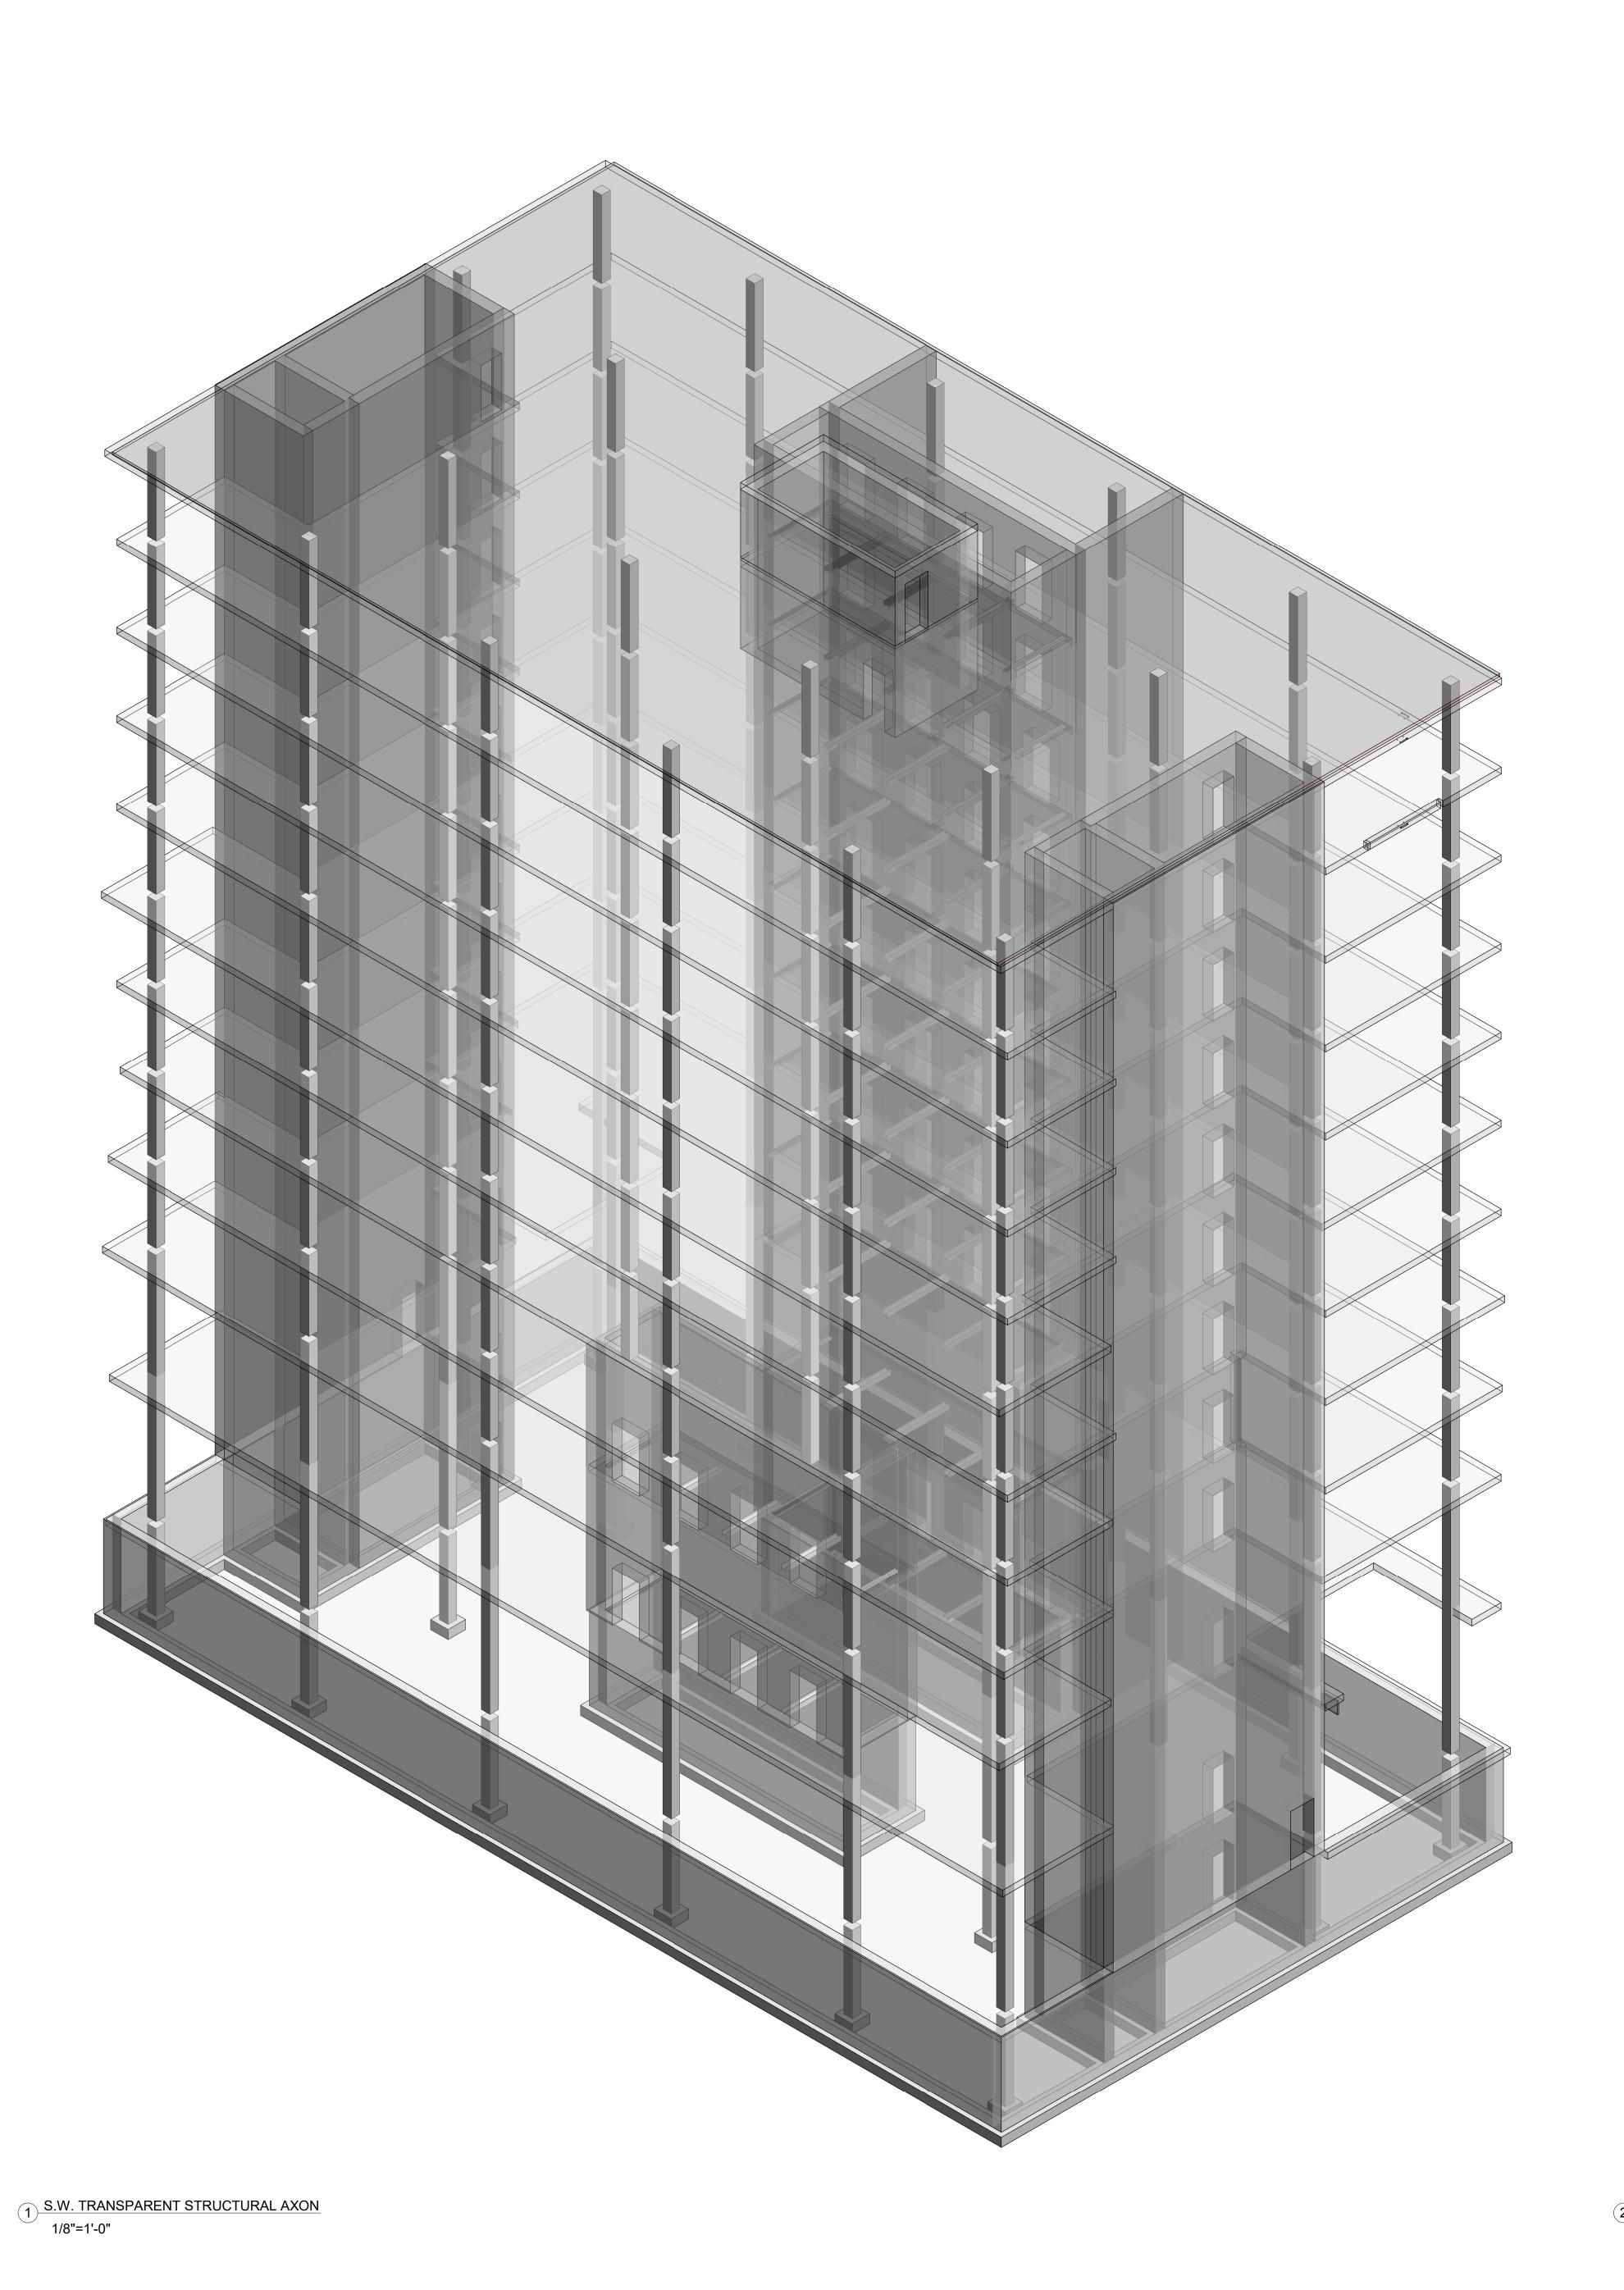


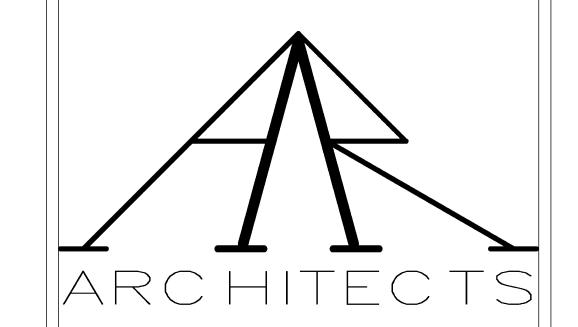

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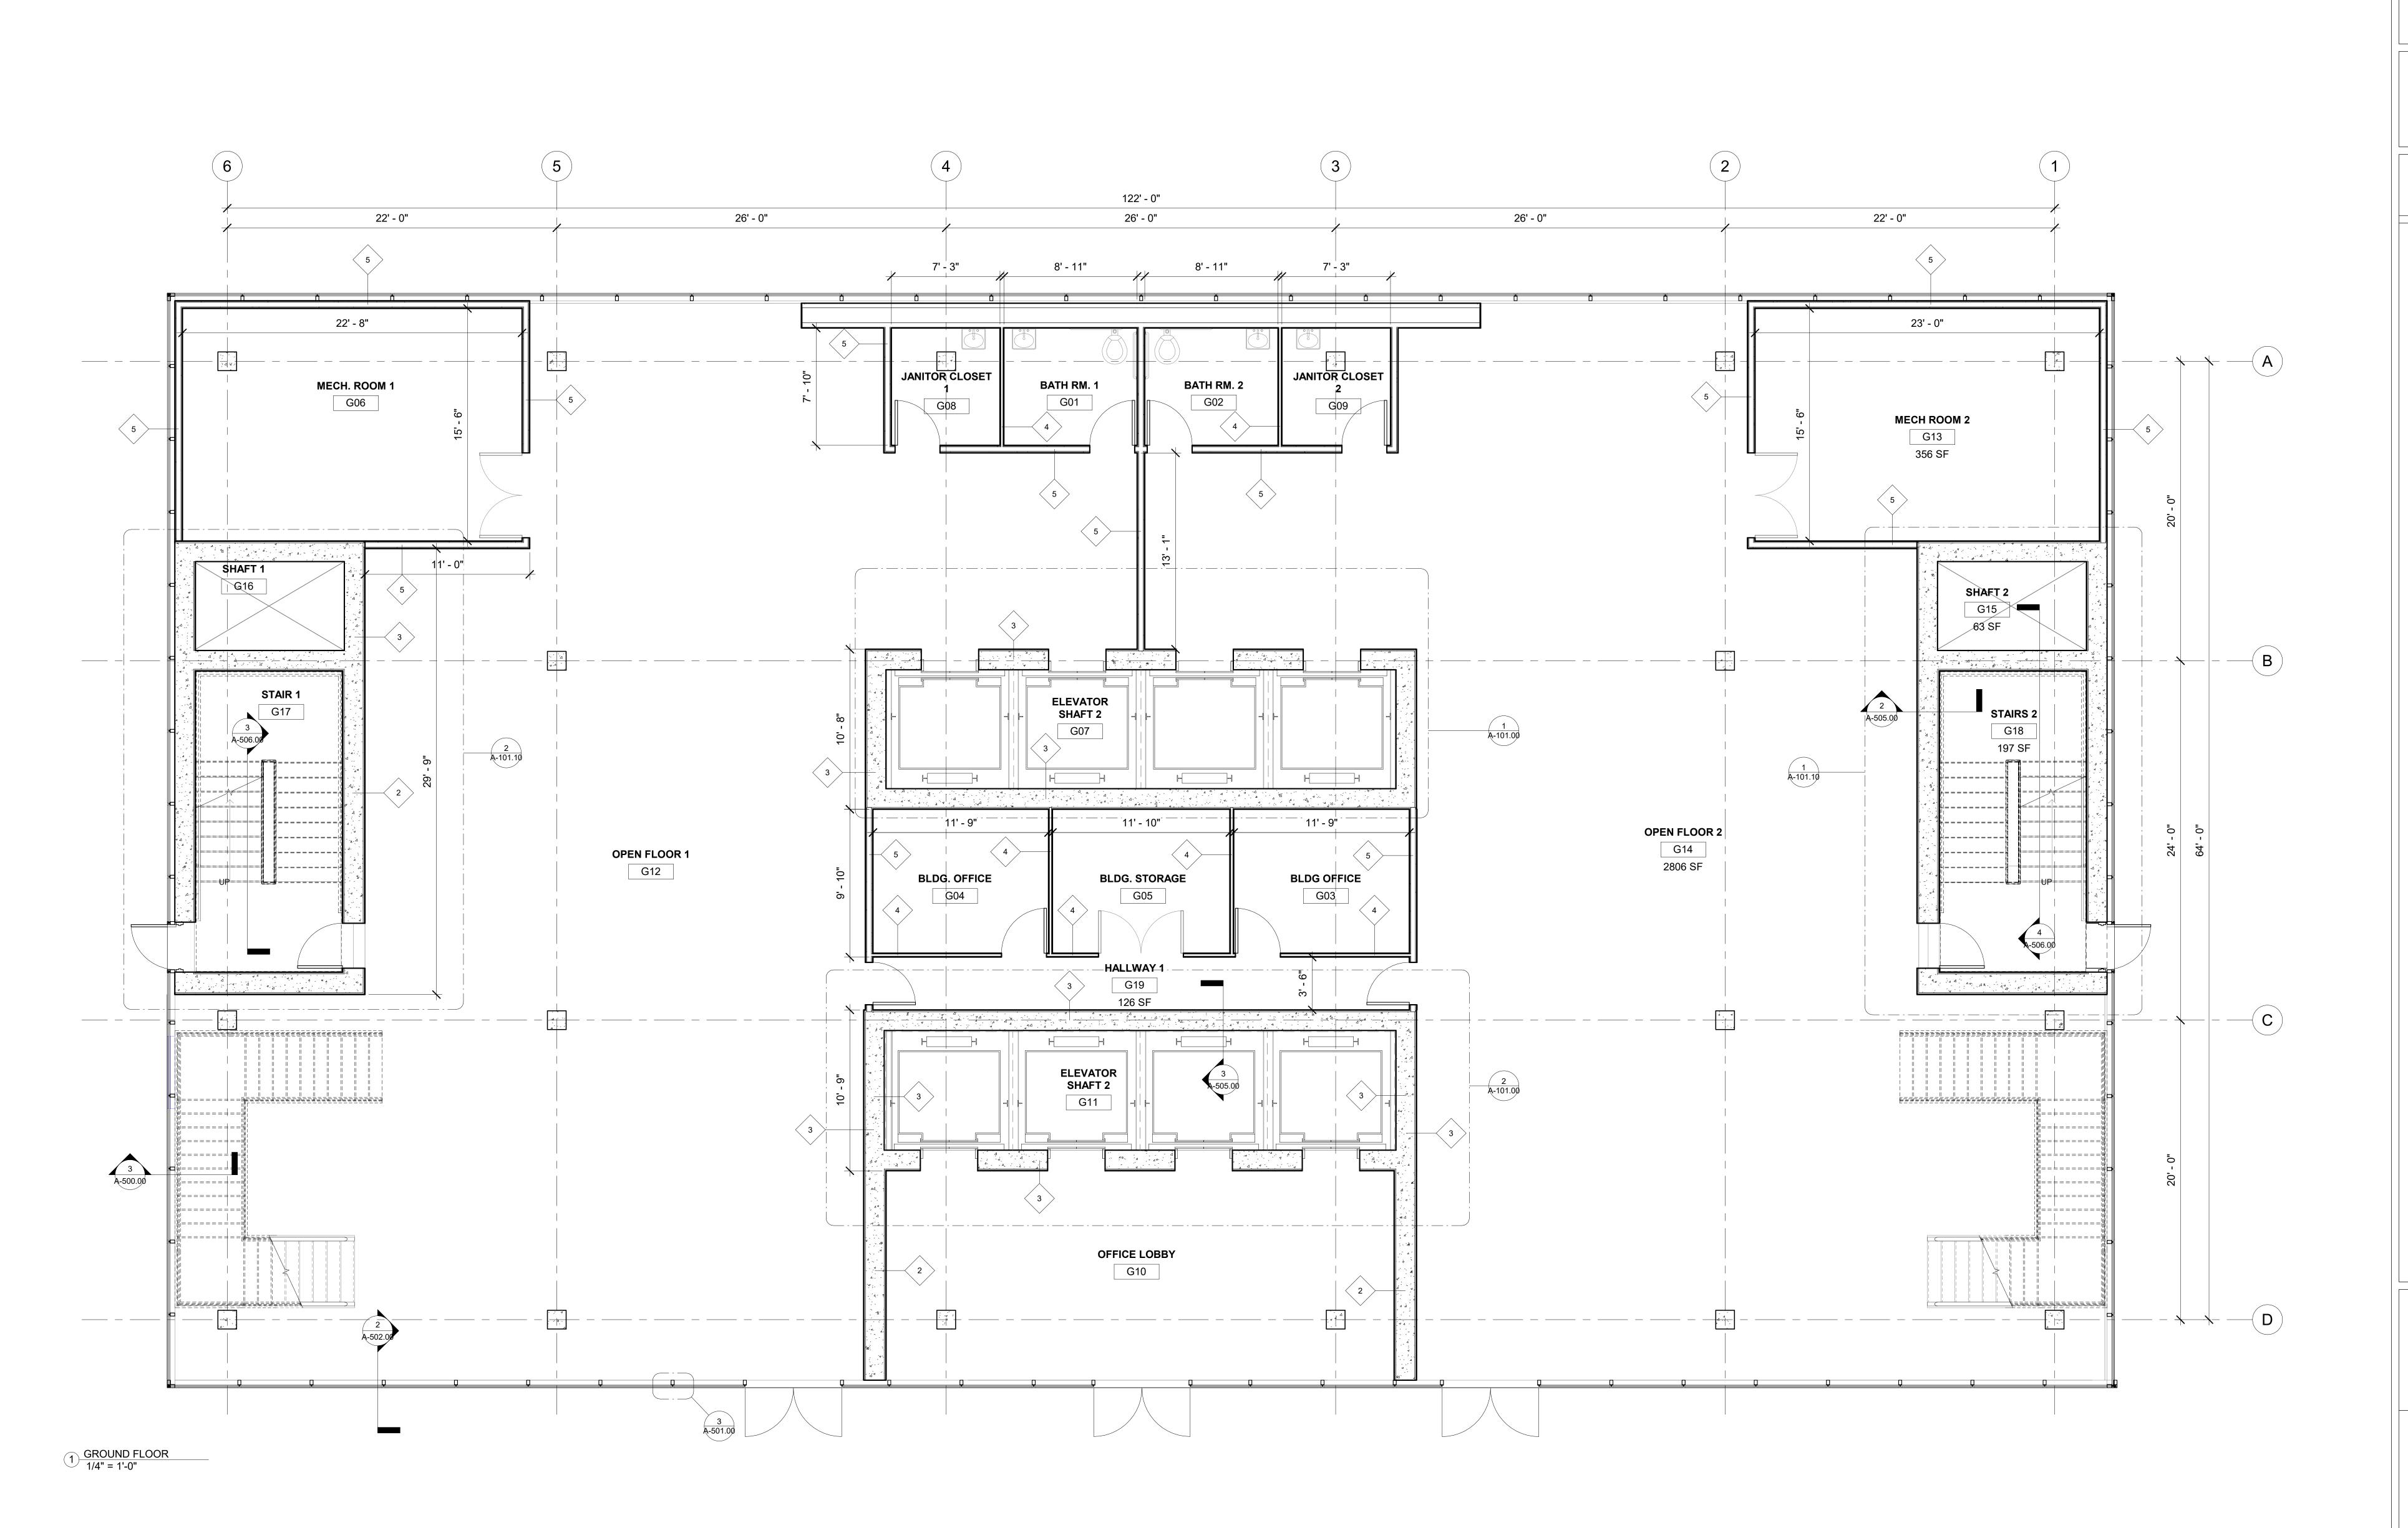
RYAN SINGH


1 JOHN STREET

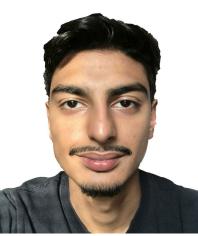3D VIEW OF CONCRETE FRAME

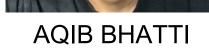Project Number Issue Date AQIB BHATTI, RYAN SINGH


1/8"=1'-0"



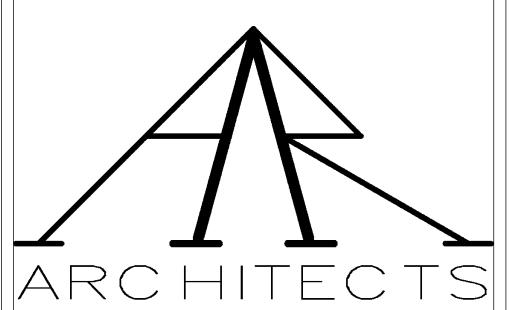

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AQIB BHATTI


RYAN SINGH
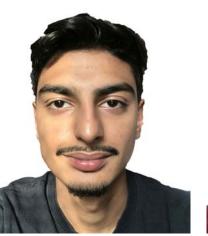
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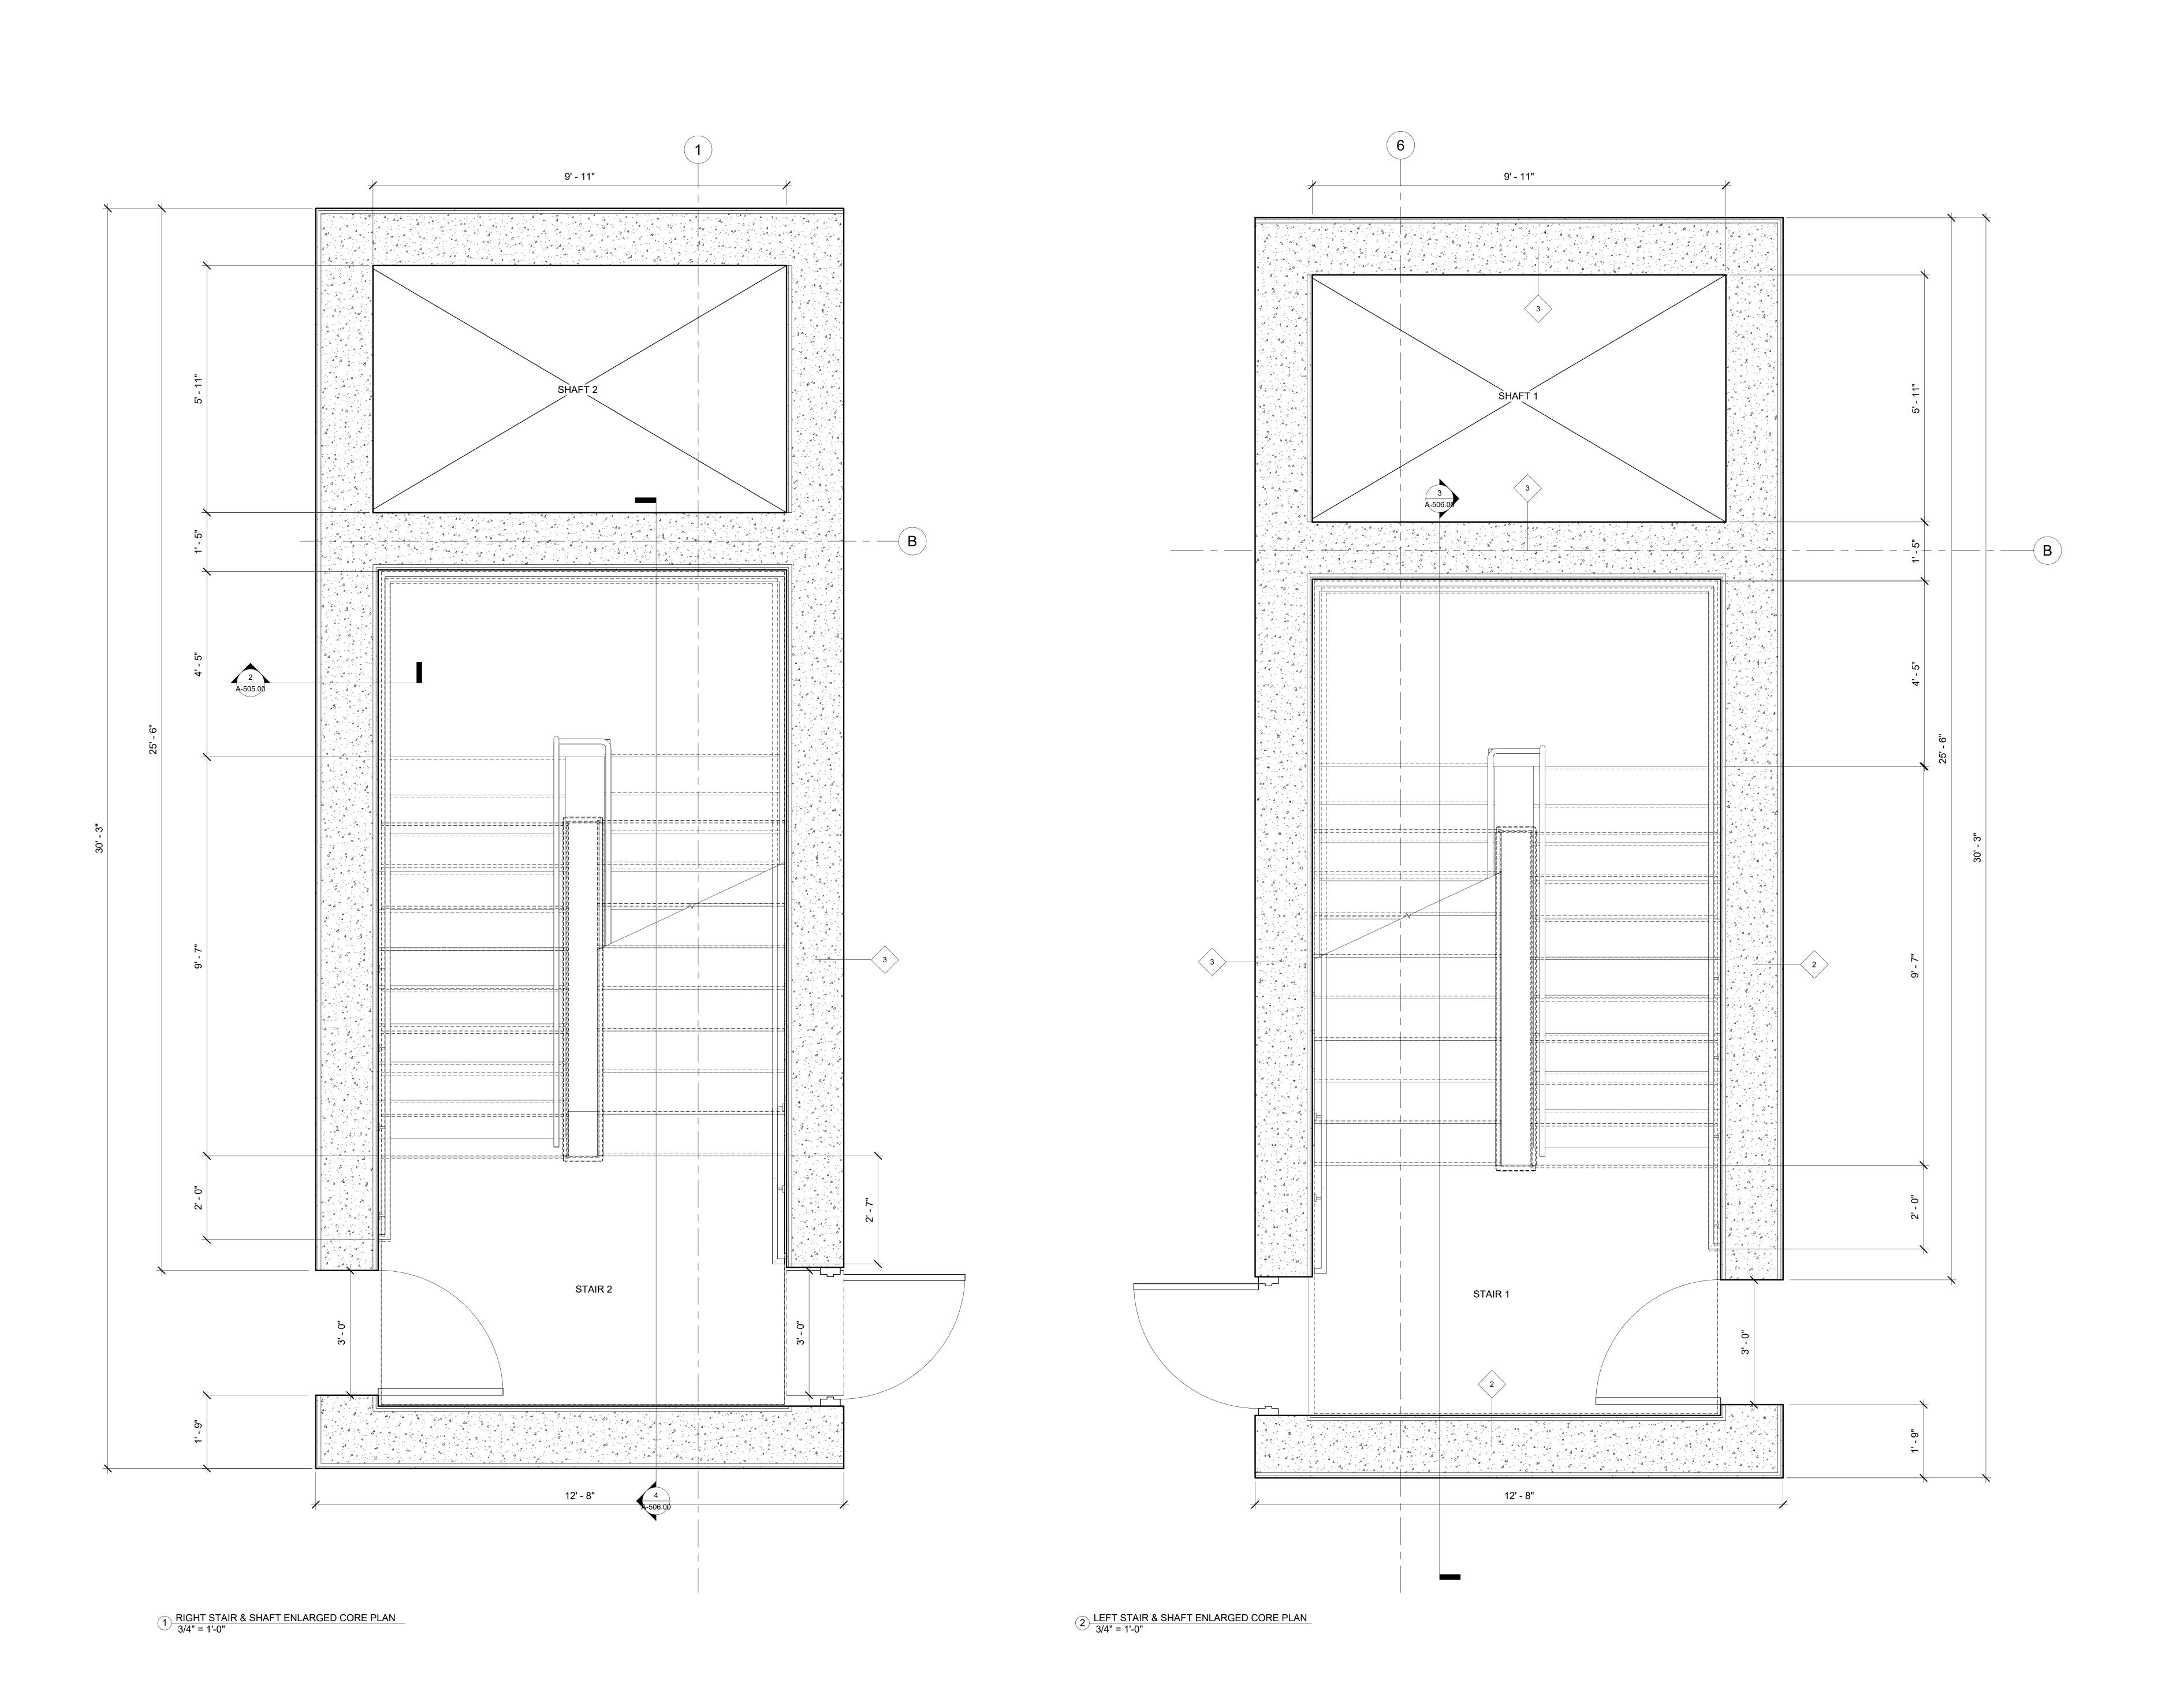
> GROUND FLOOR PLAN

Project Number Issue Date AQIB BHATTI Checker

A-100.00

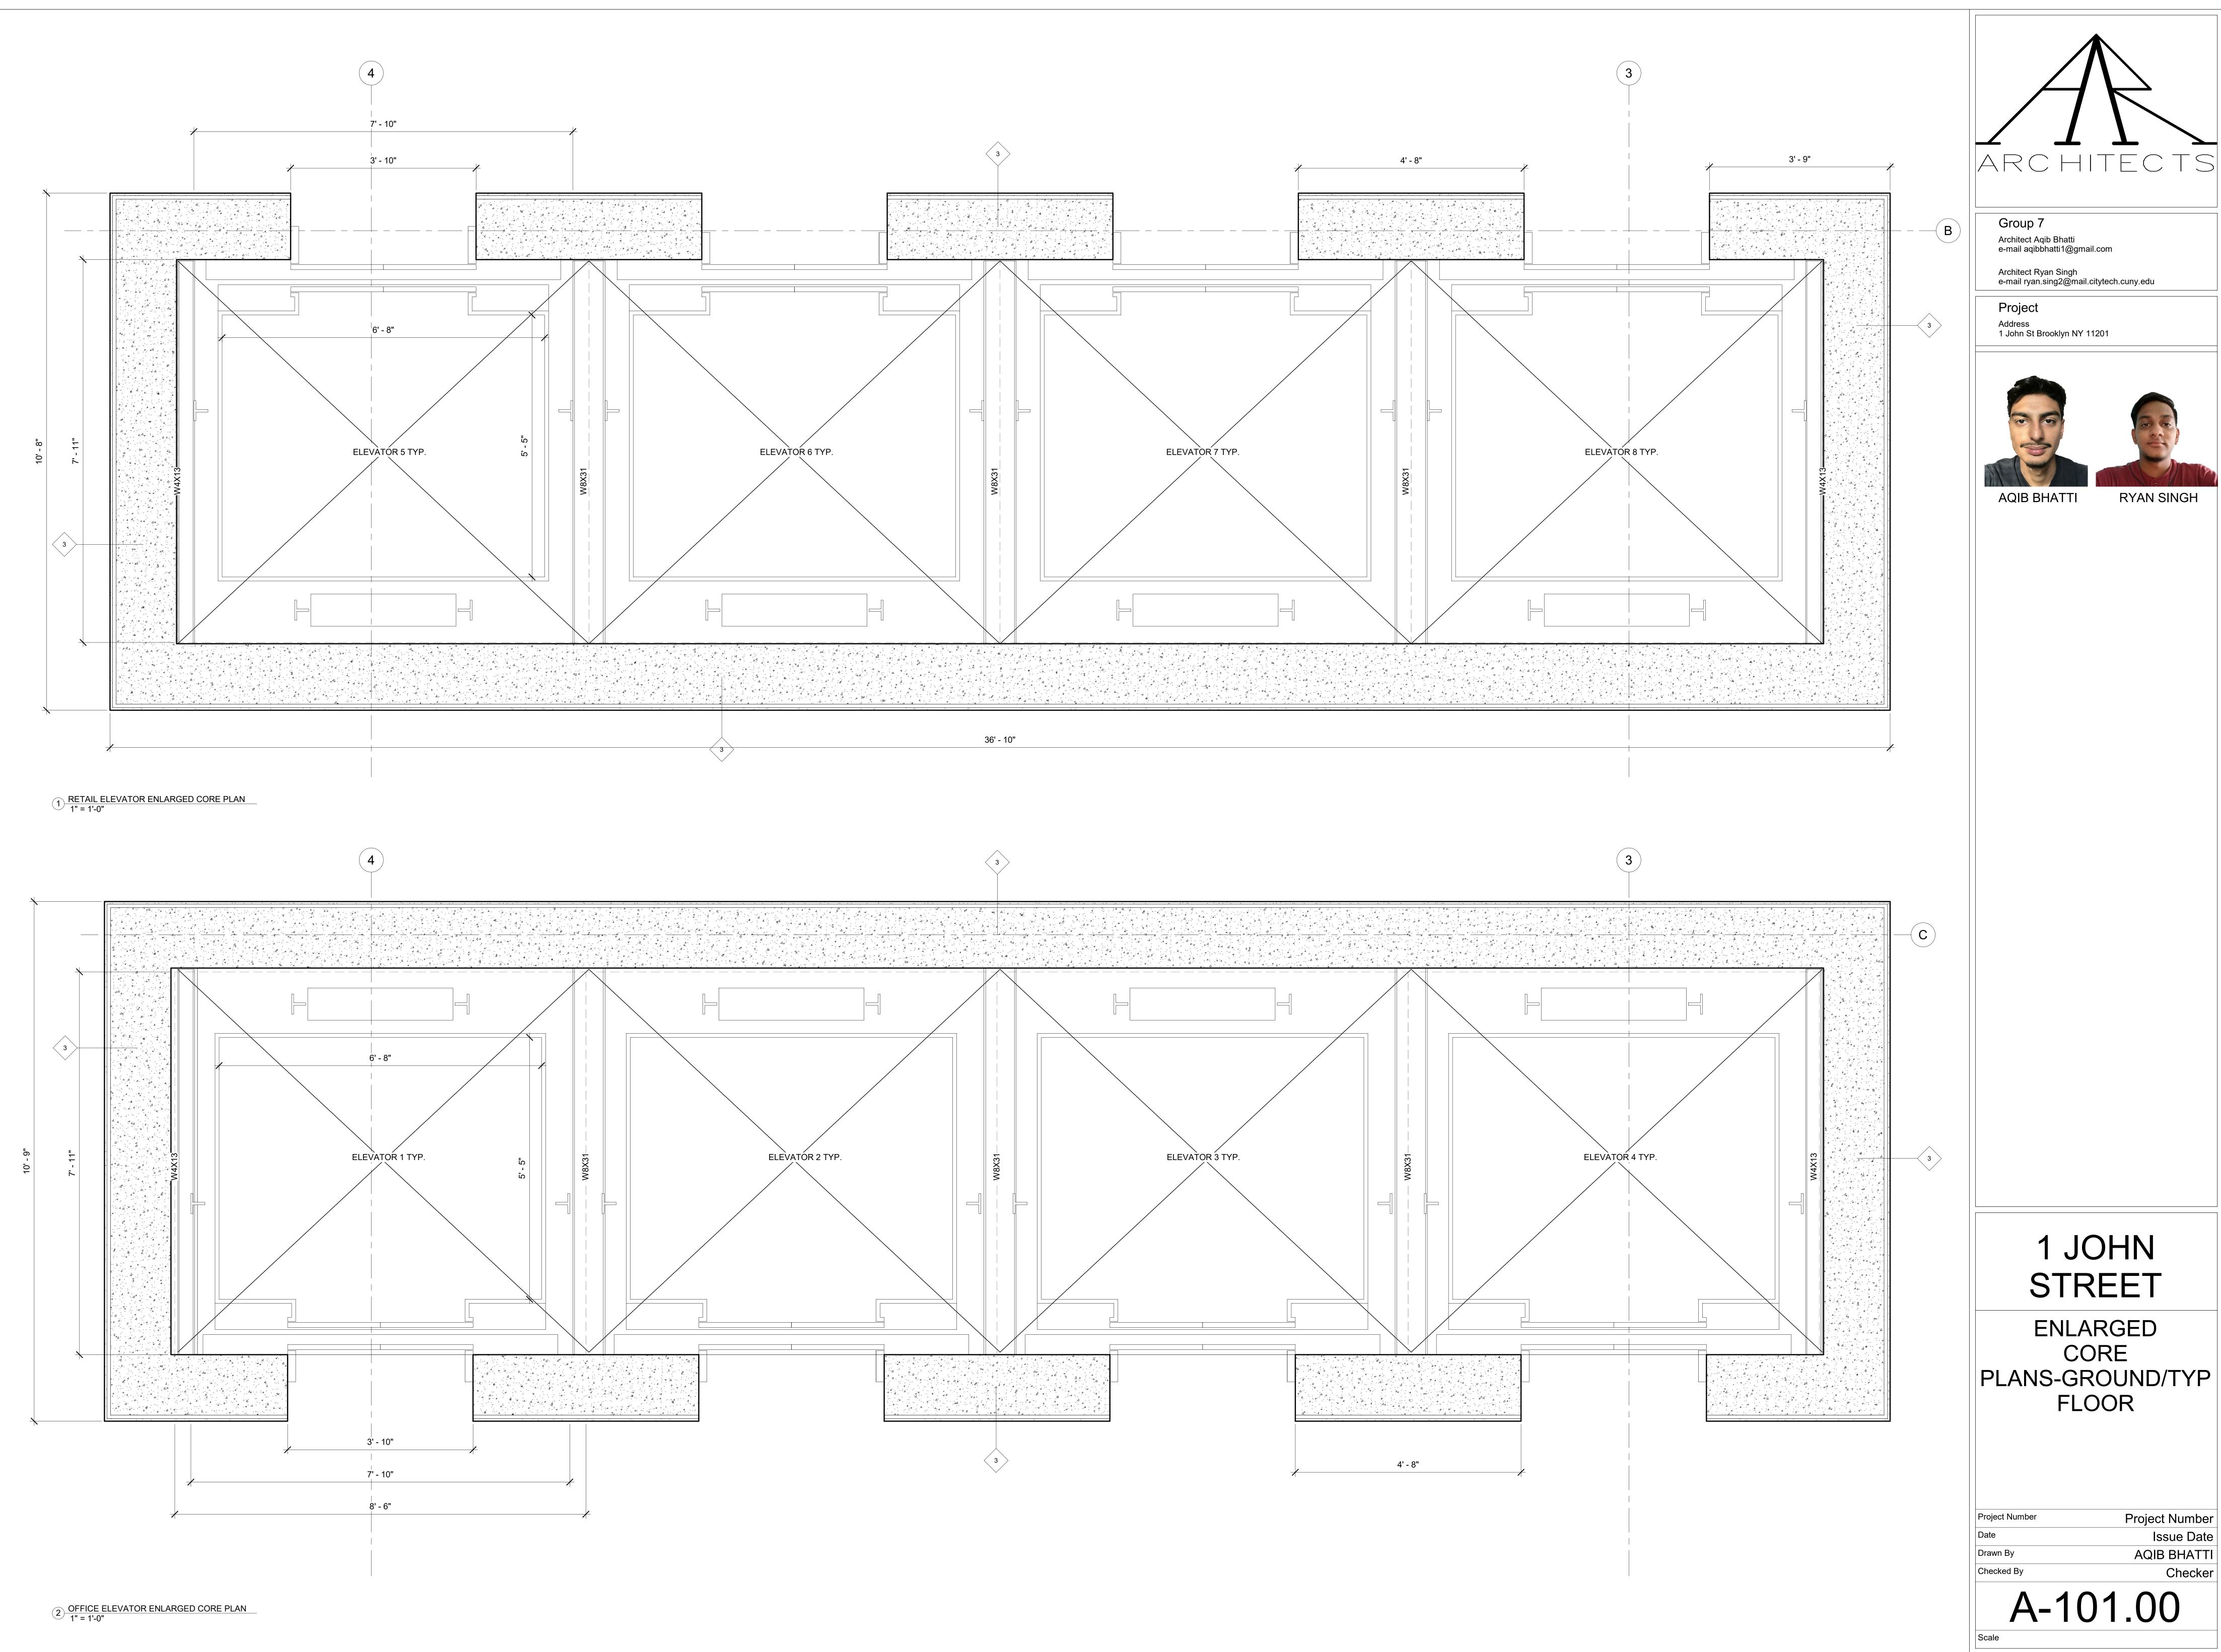

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RYAN SINGH


AQIB BHATTI

1 JOHN STREET

ENLARGED CORE **PLANS** GROUND/TYP **FLOOR**

Project Number Issue Date RYAN SINGH Checker


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ATTI RYAN SINGH

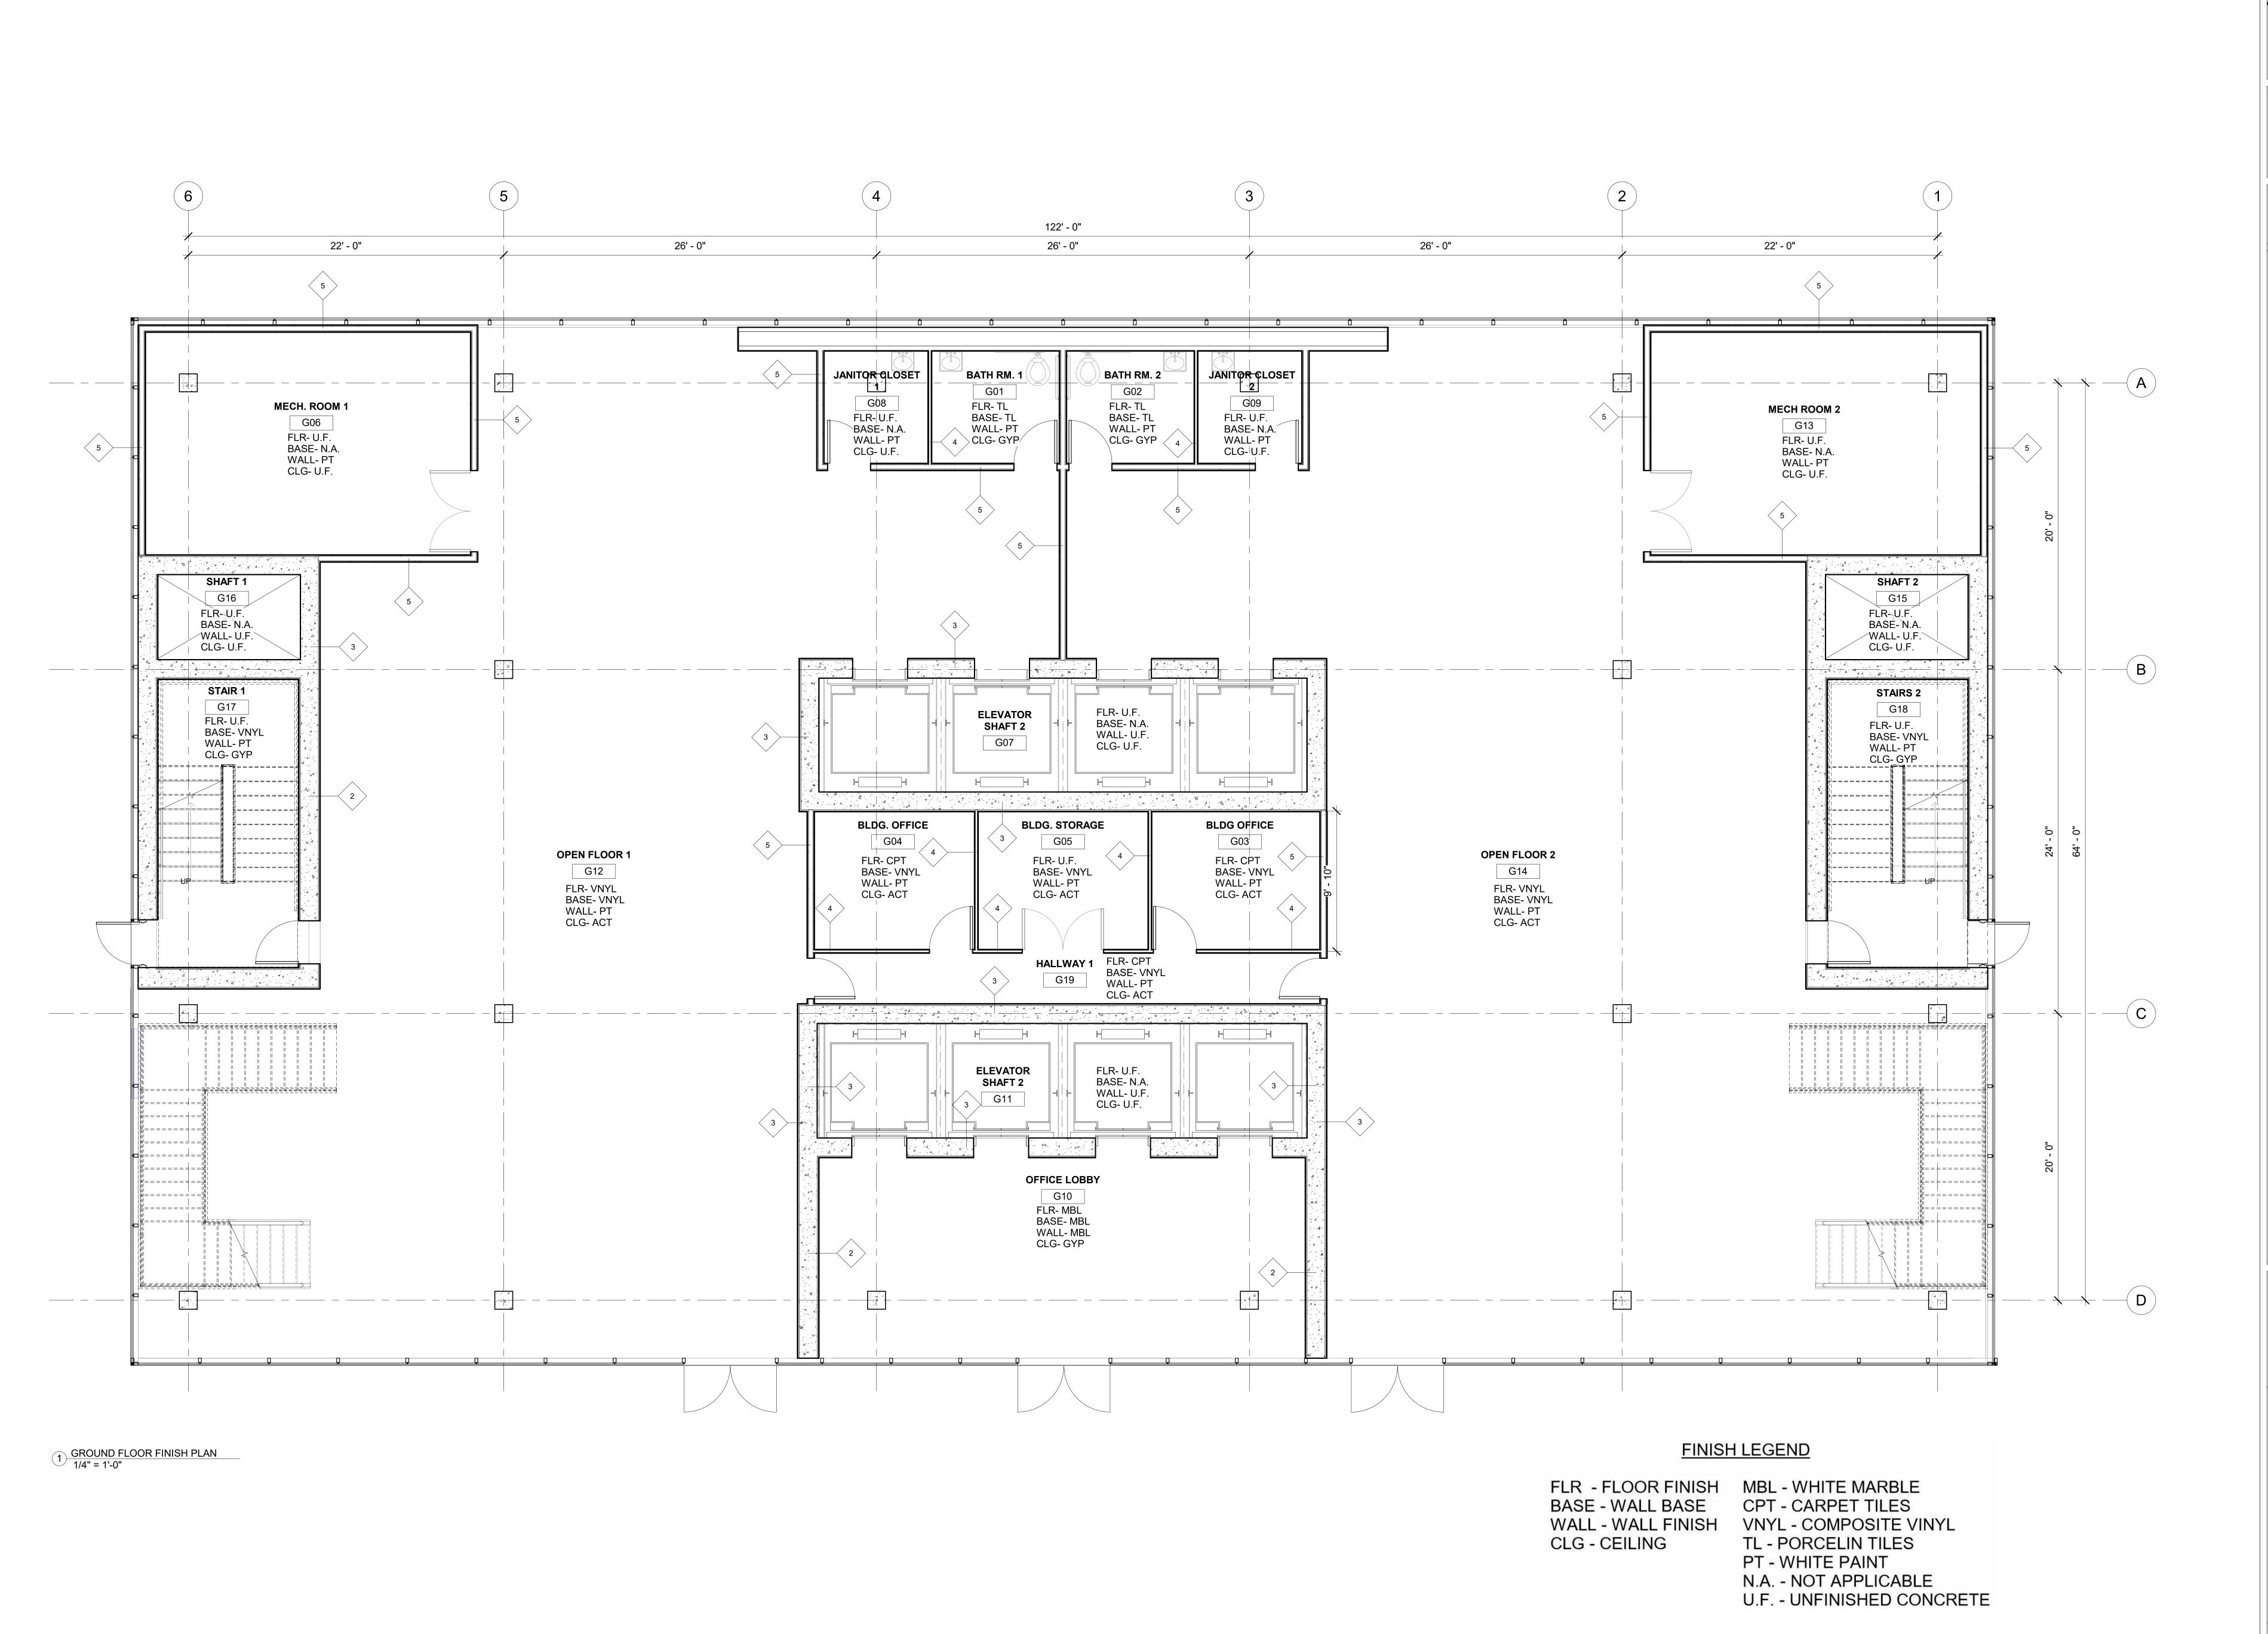
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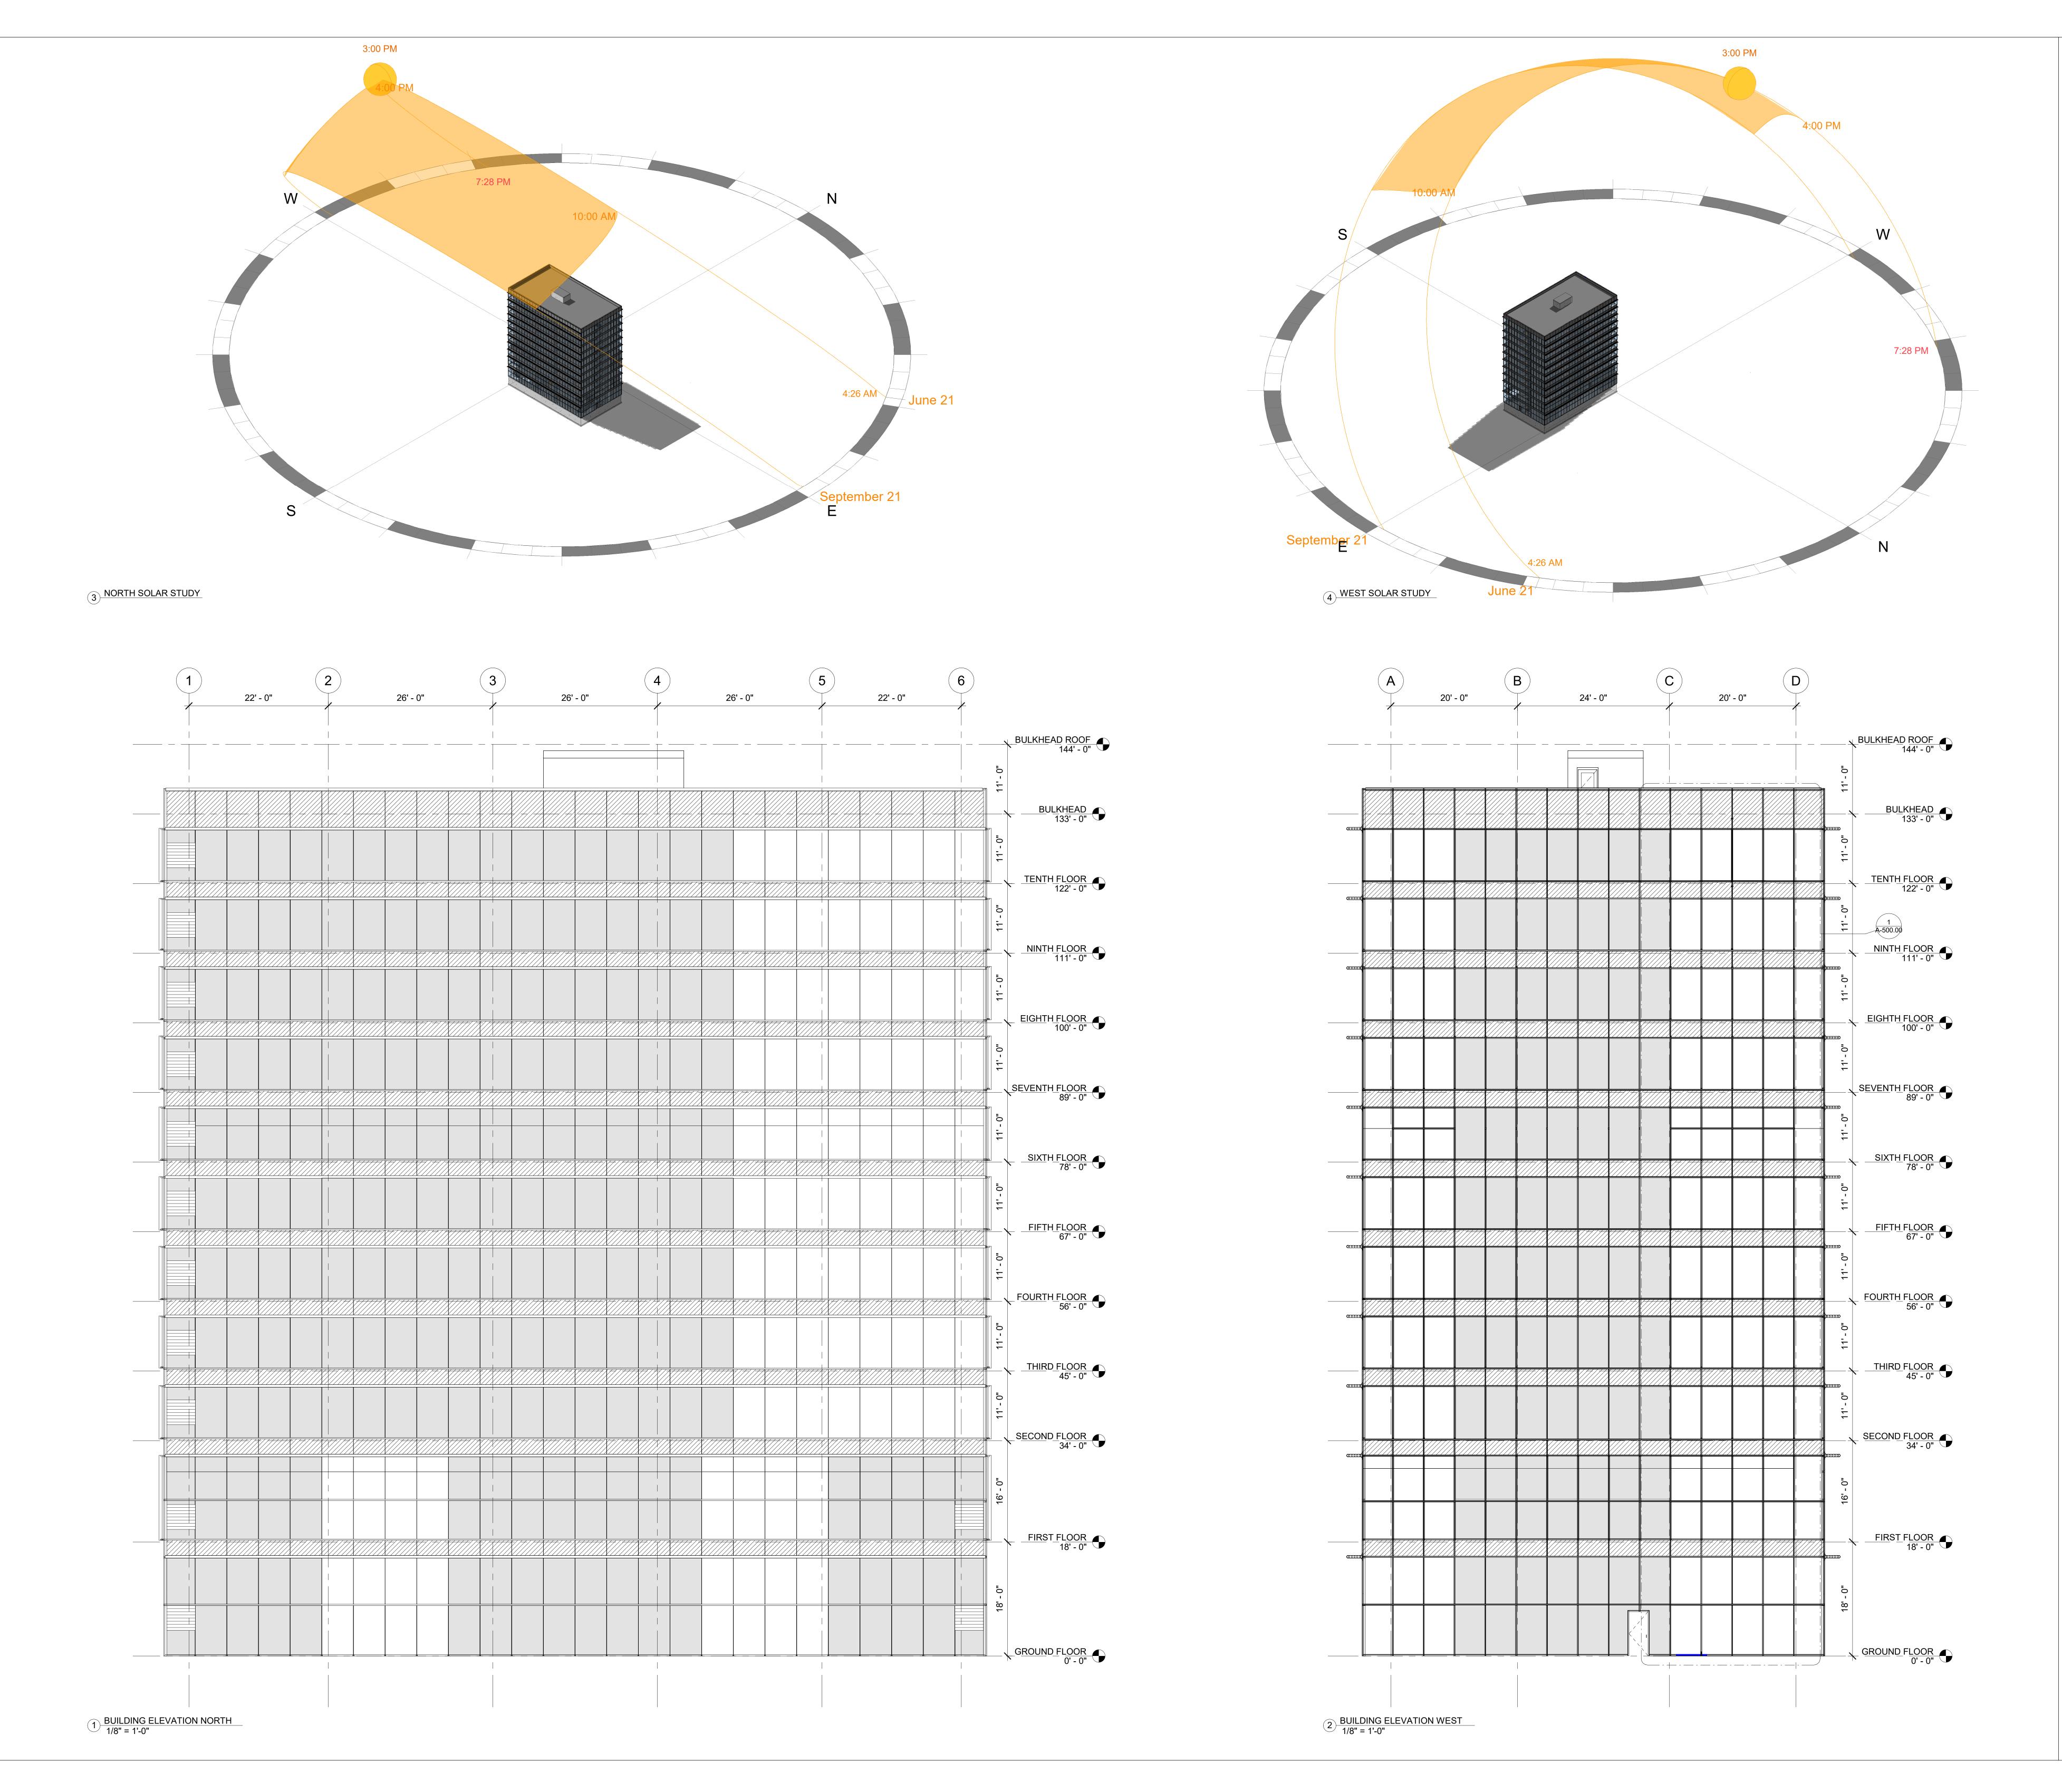
FINISH PLAN-GROUND FLOOR

Project Number	Project Numbe
Date	Issue Date
Drawn By	AQIB BHATT
Checked By	Checke

A-102.00

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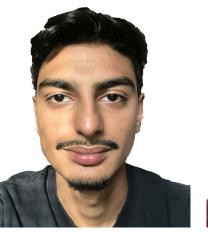


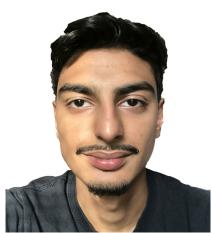
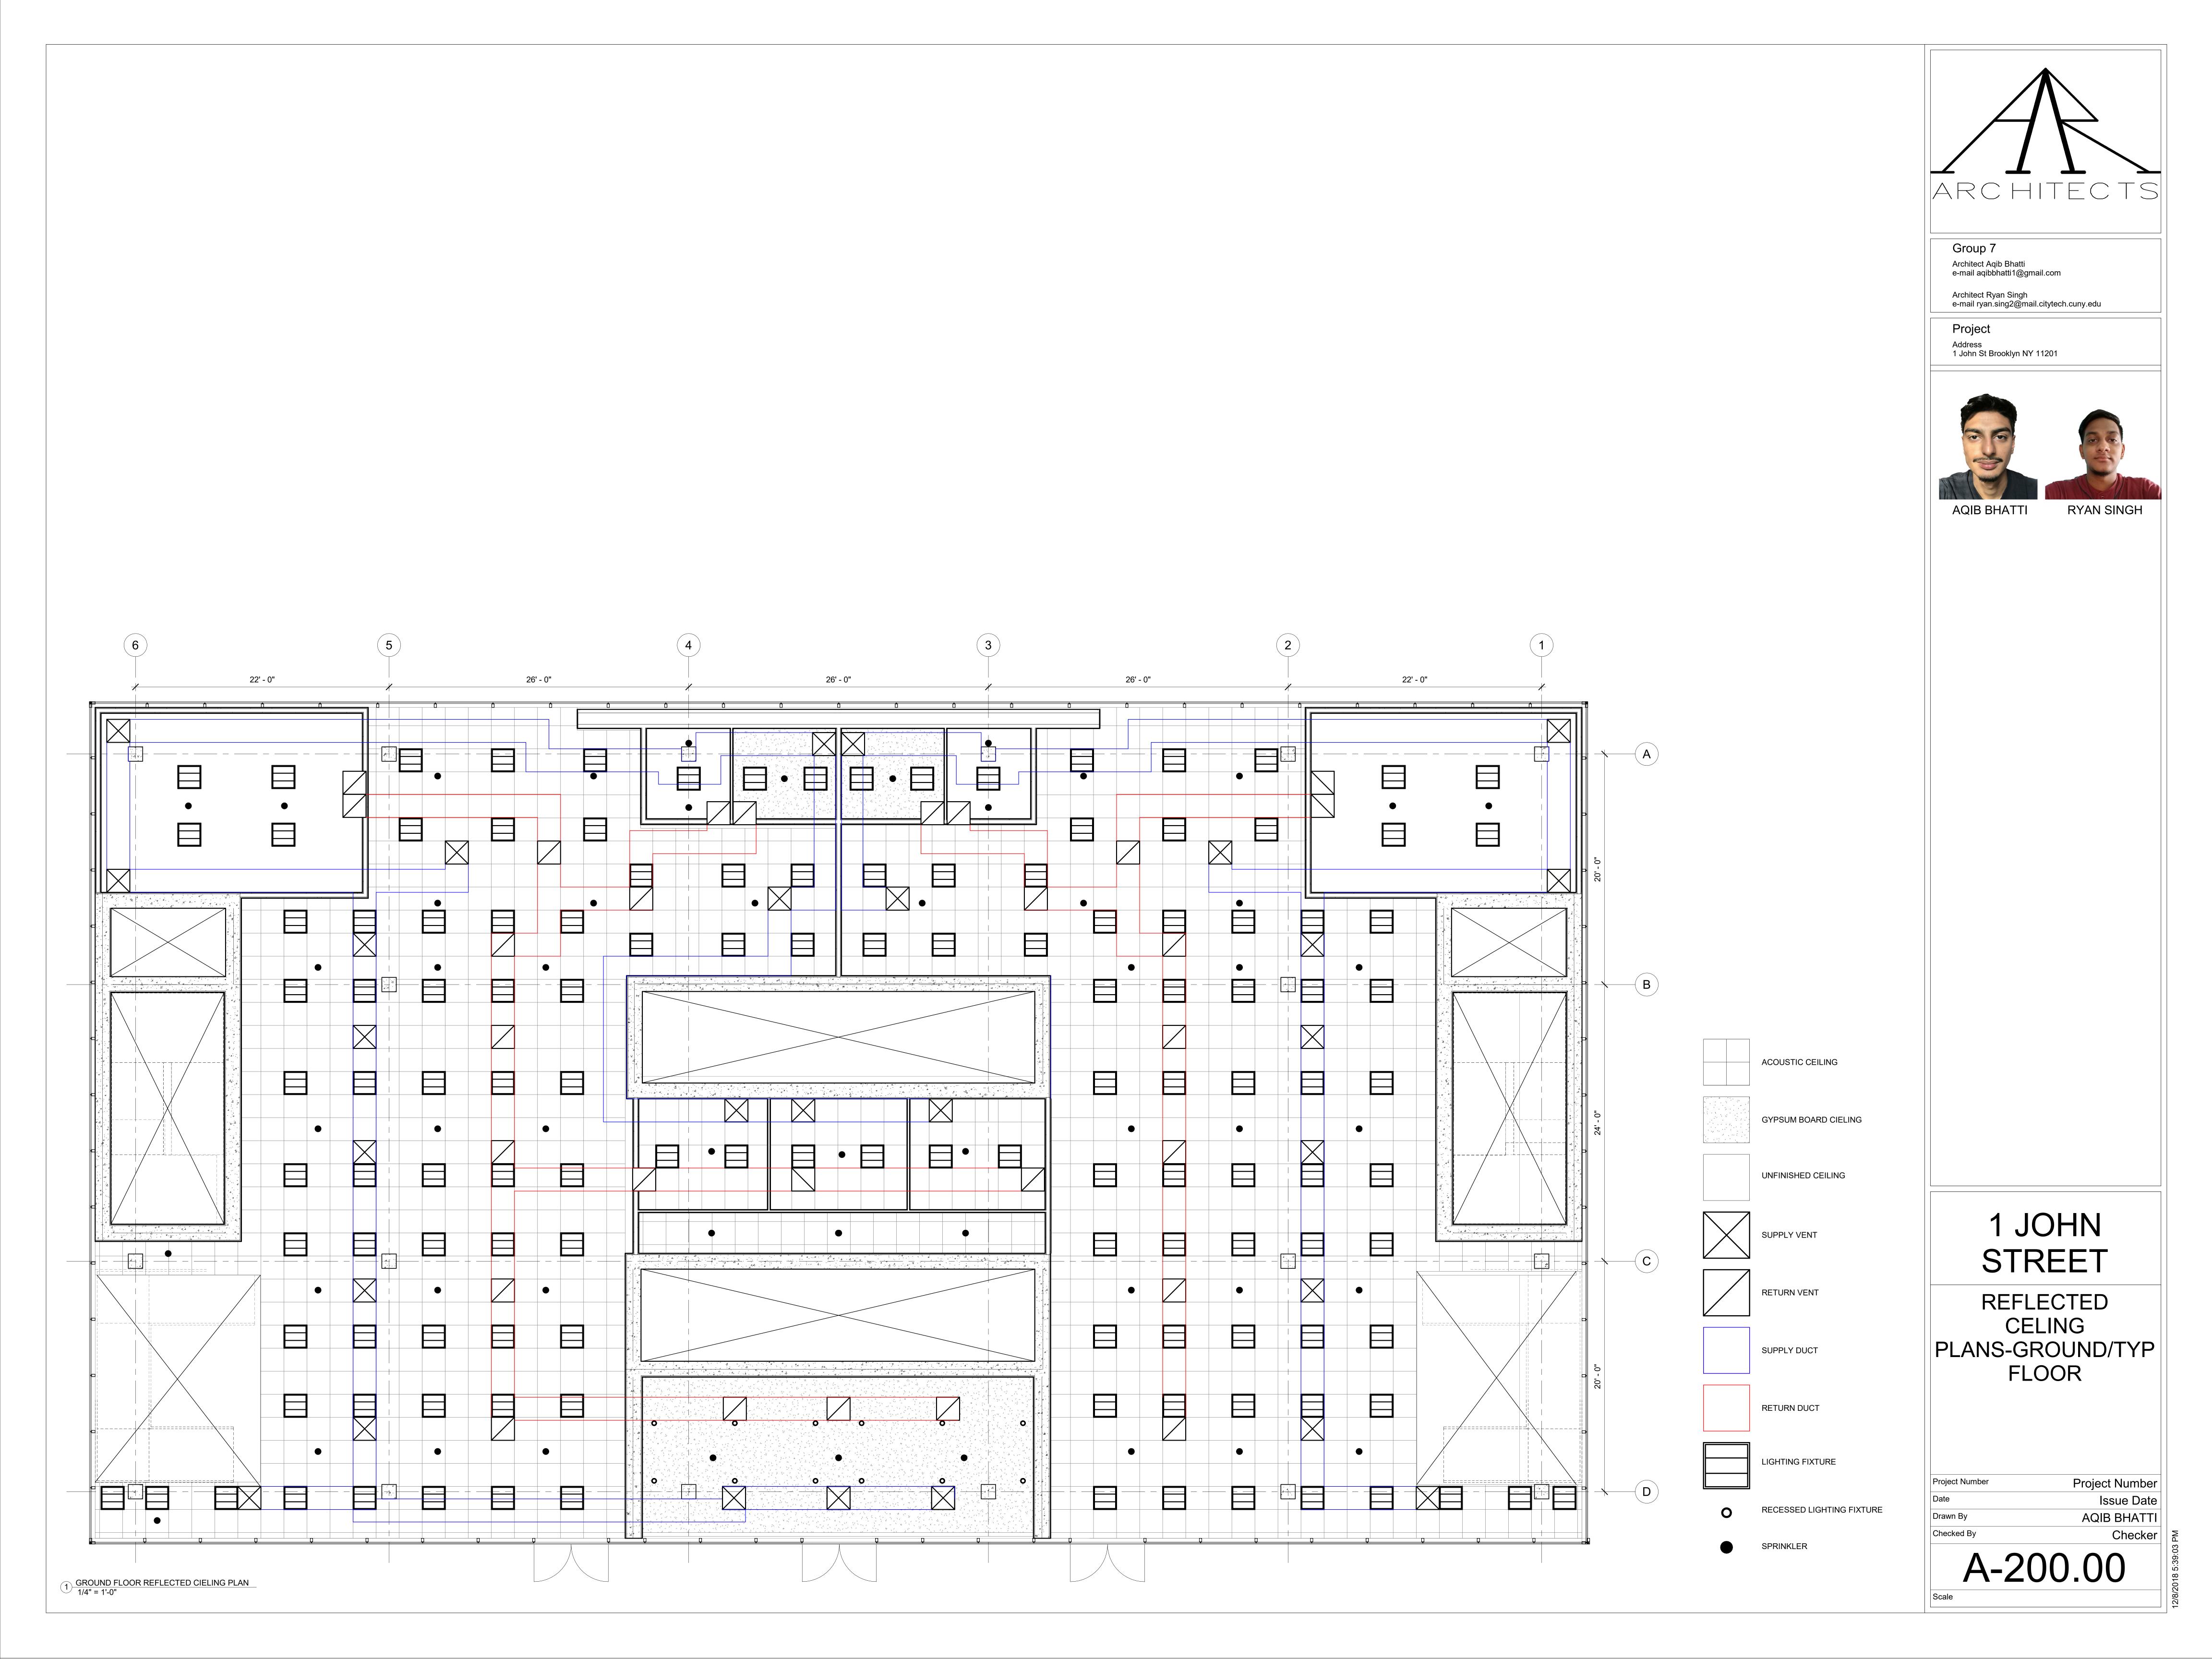
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AQIB BHATTI

TTI RYAN SINGH


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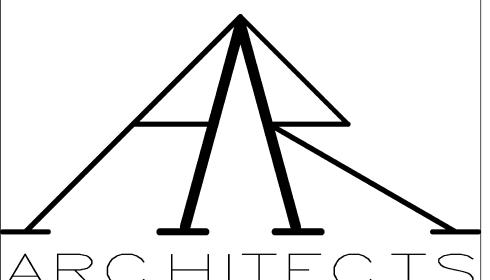
OVERALL ELEVATIONS NORTH AND WEST

Project Number	Project Number
Date	Issue Da
Drawn By	RYAN SING
Checked By	Check

A-300.00


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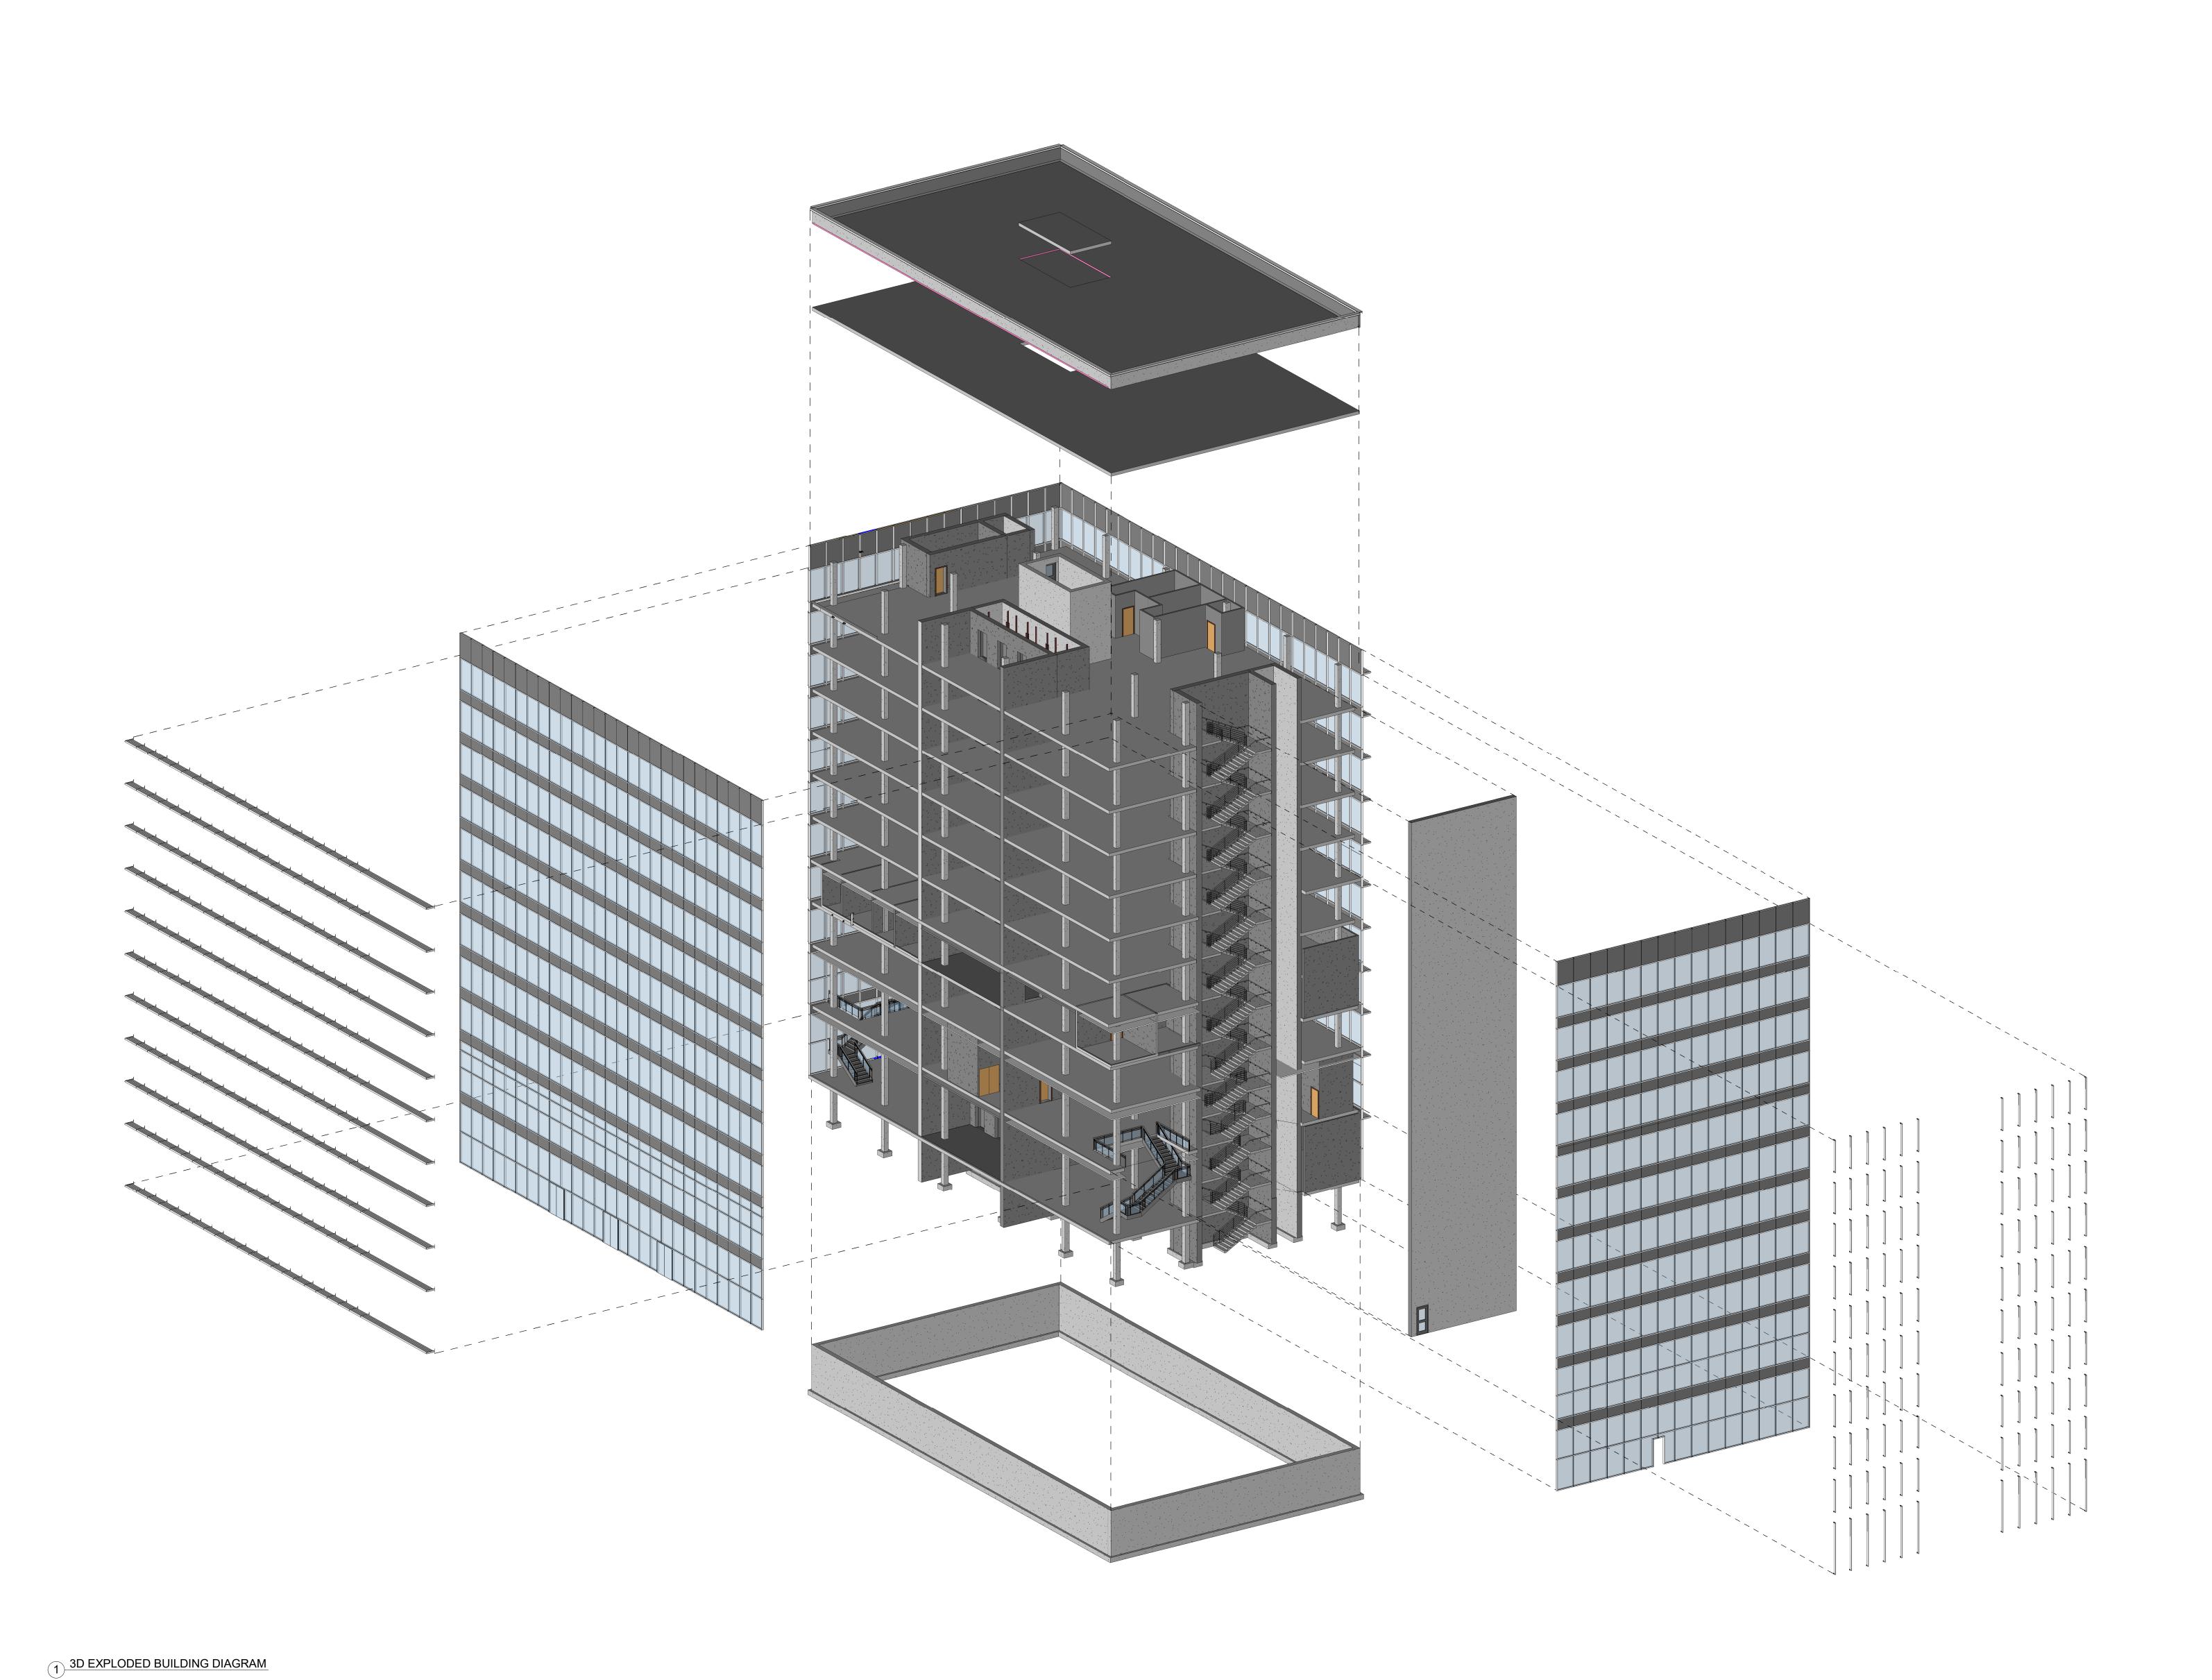
RYAN SINGH

1 JOHN STREET

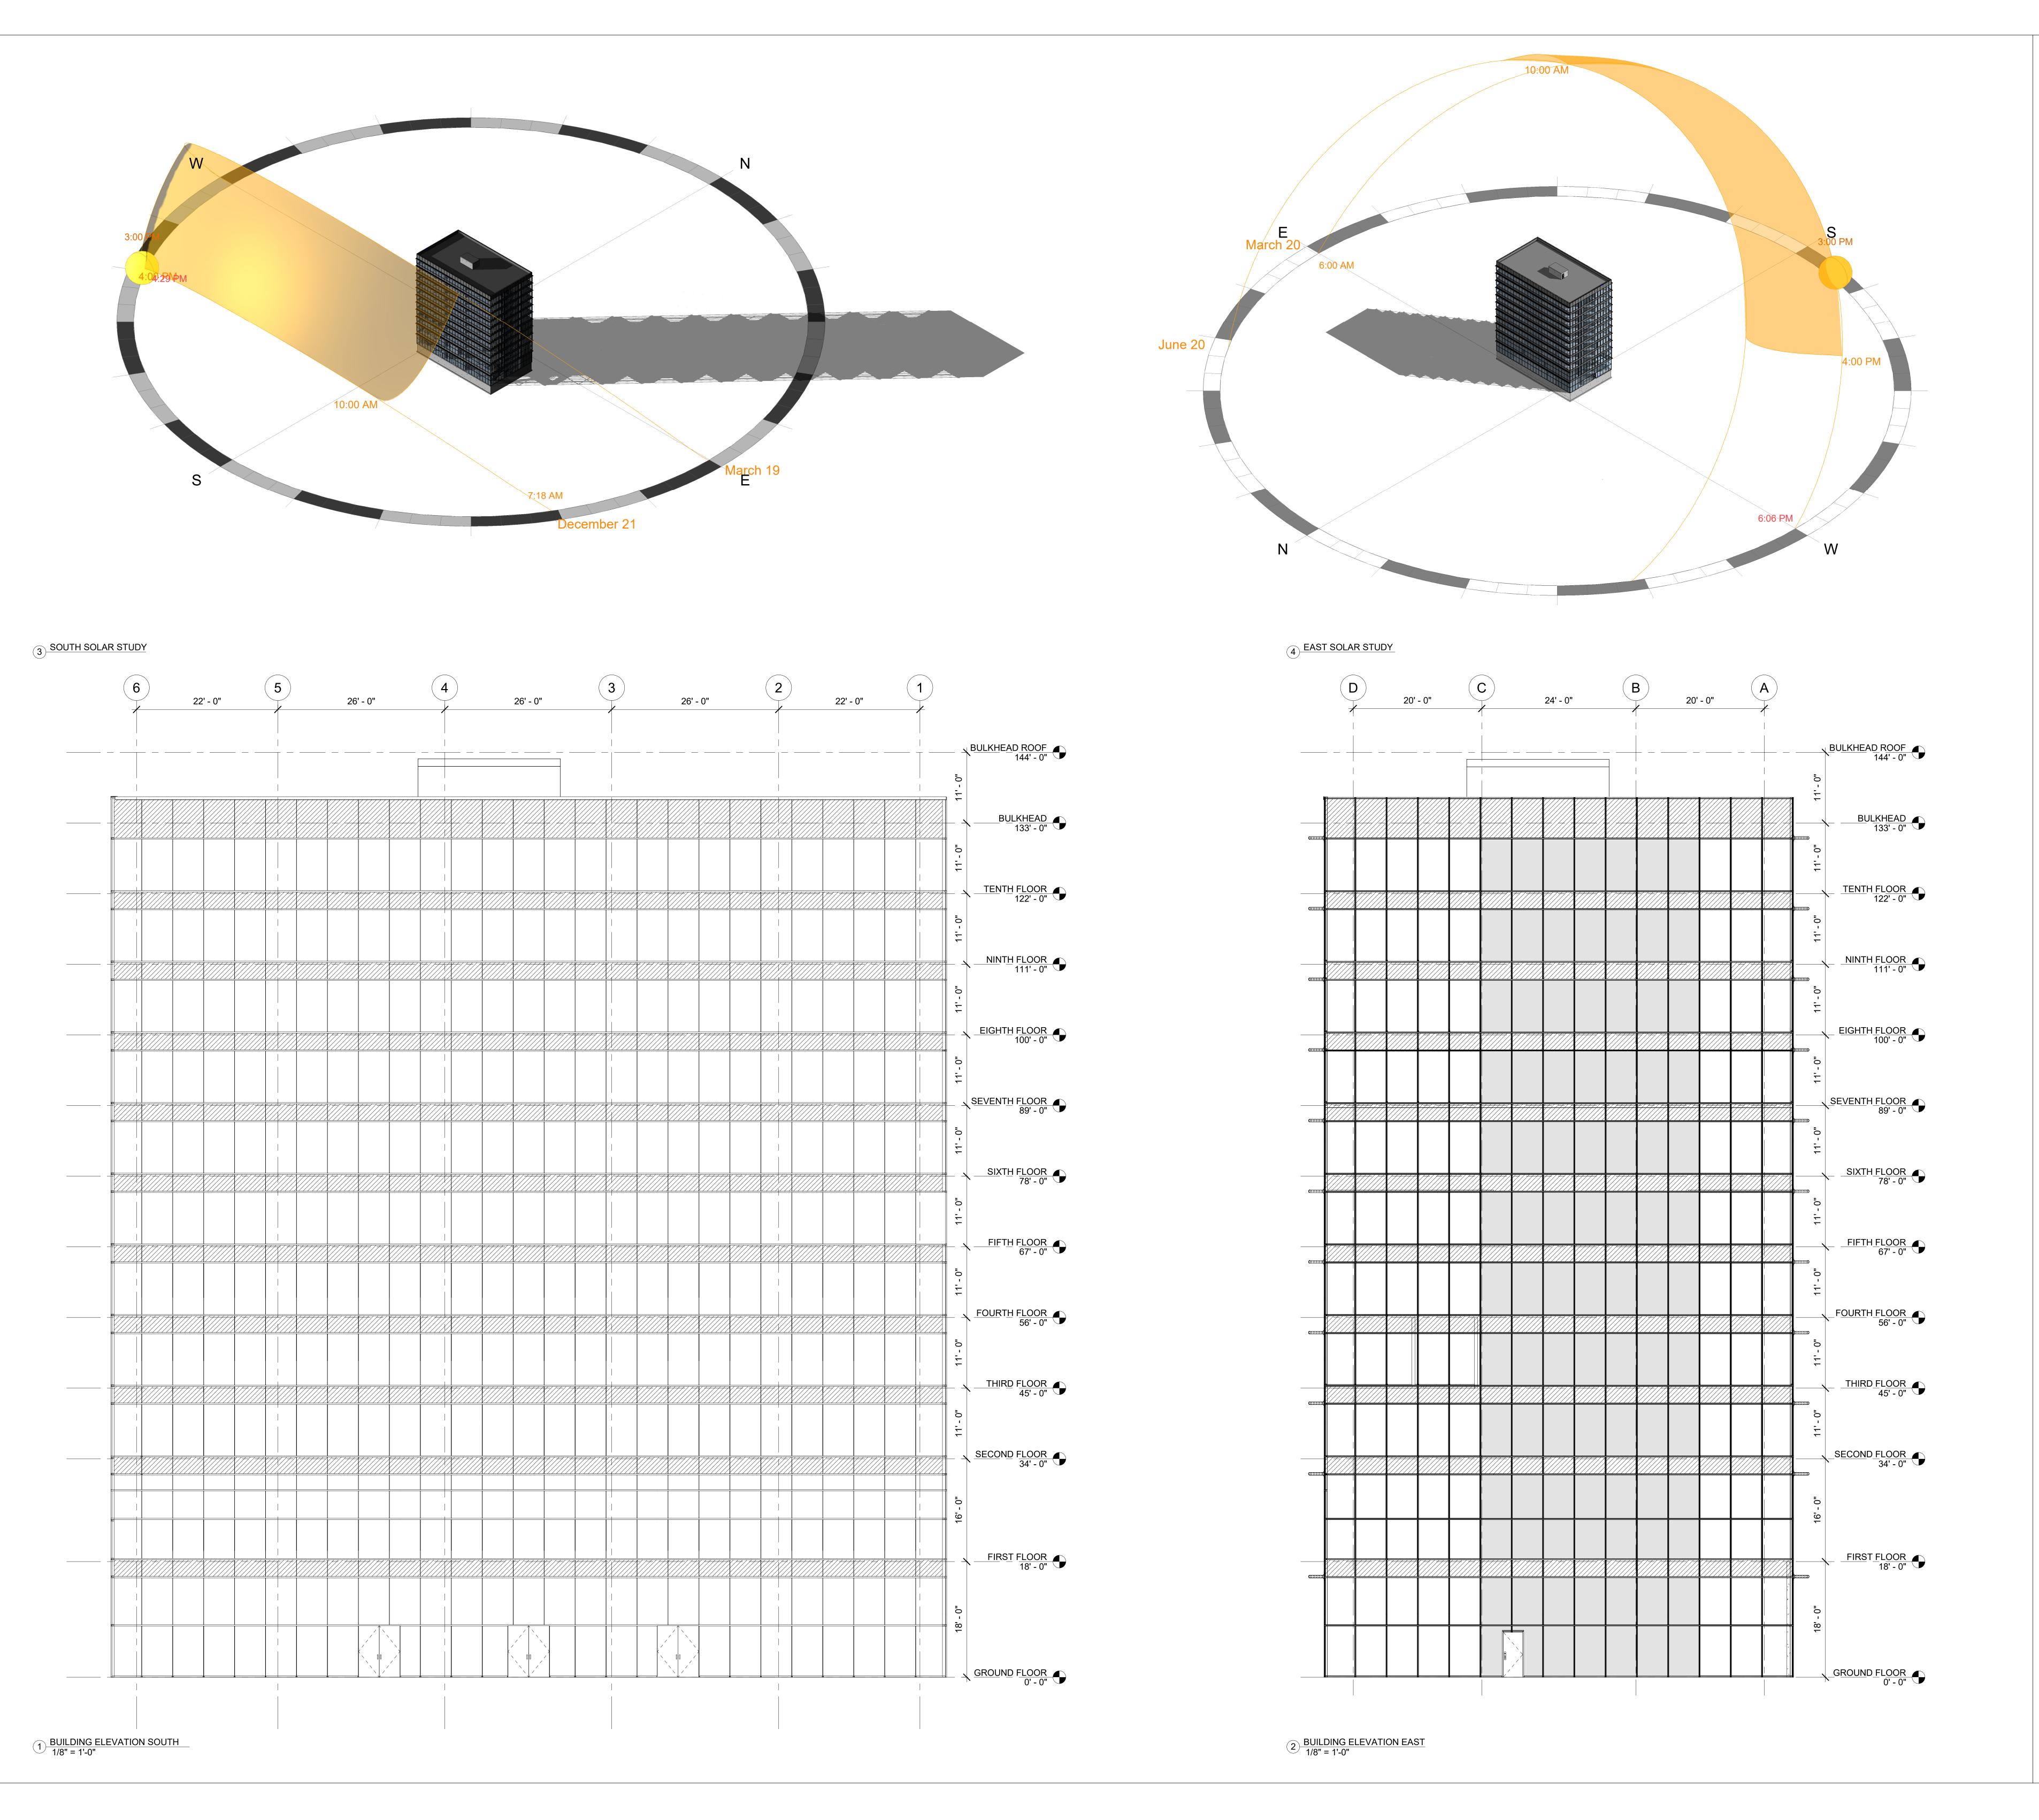OVERALL ELEVATIONS SOUTH AND EAST

Project Number	Project Number
Date	Issue Da
Drawn By	RYAN SING
Checked By	Check

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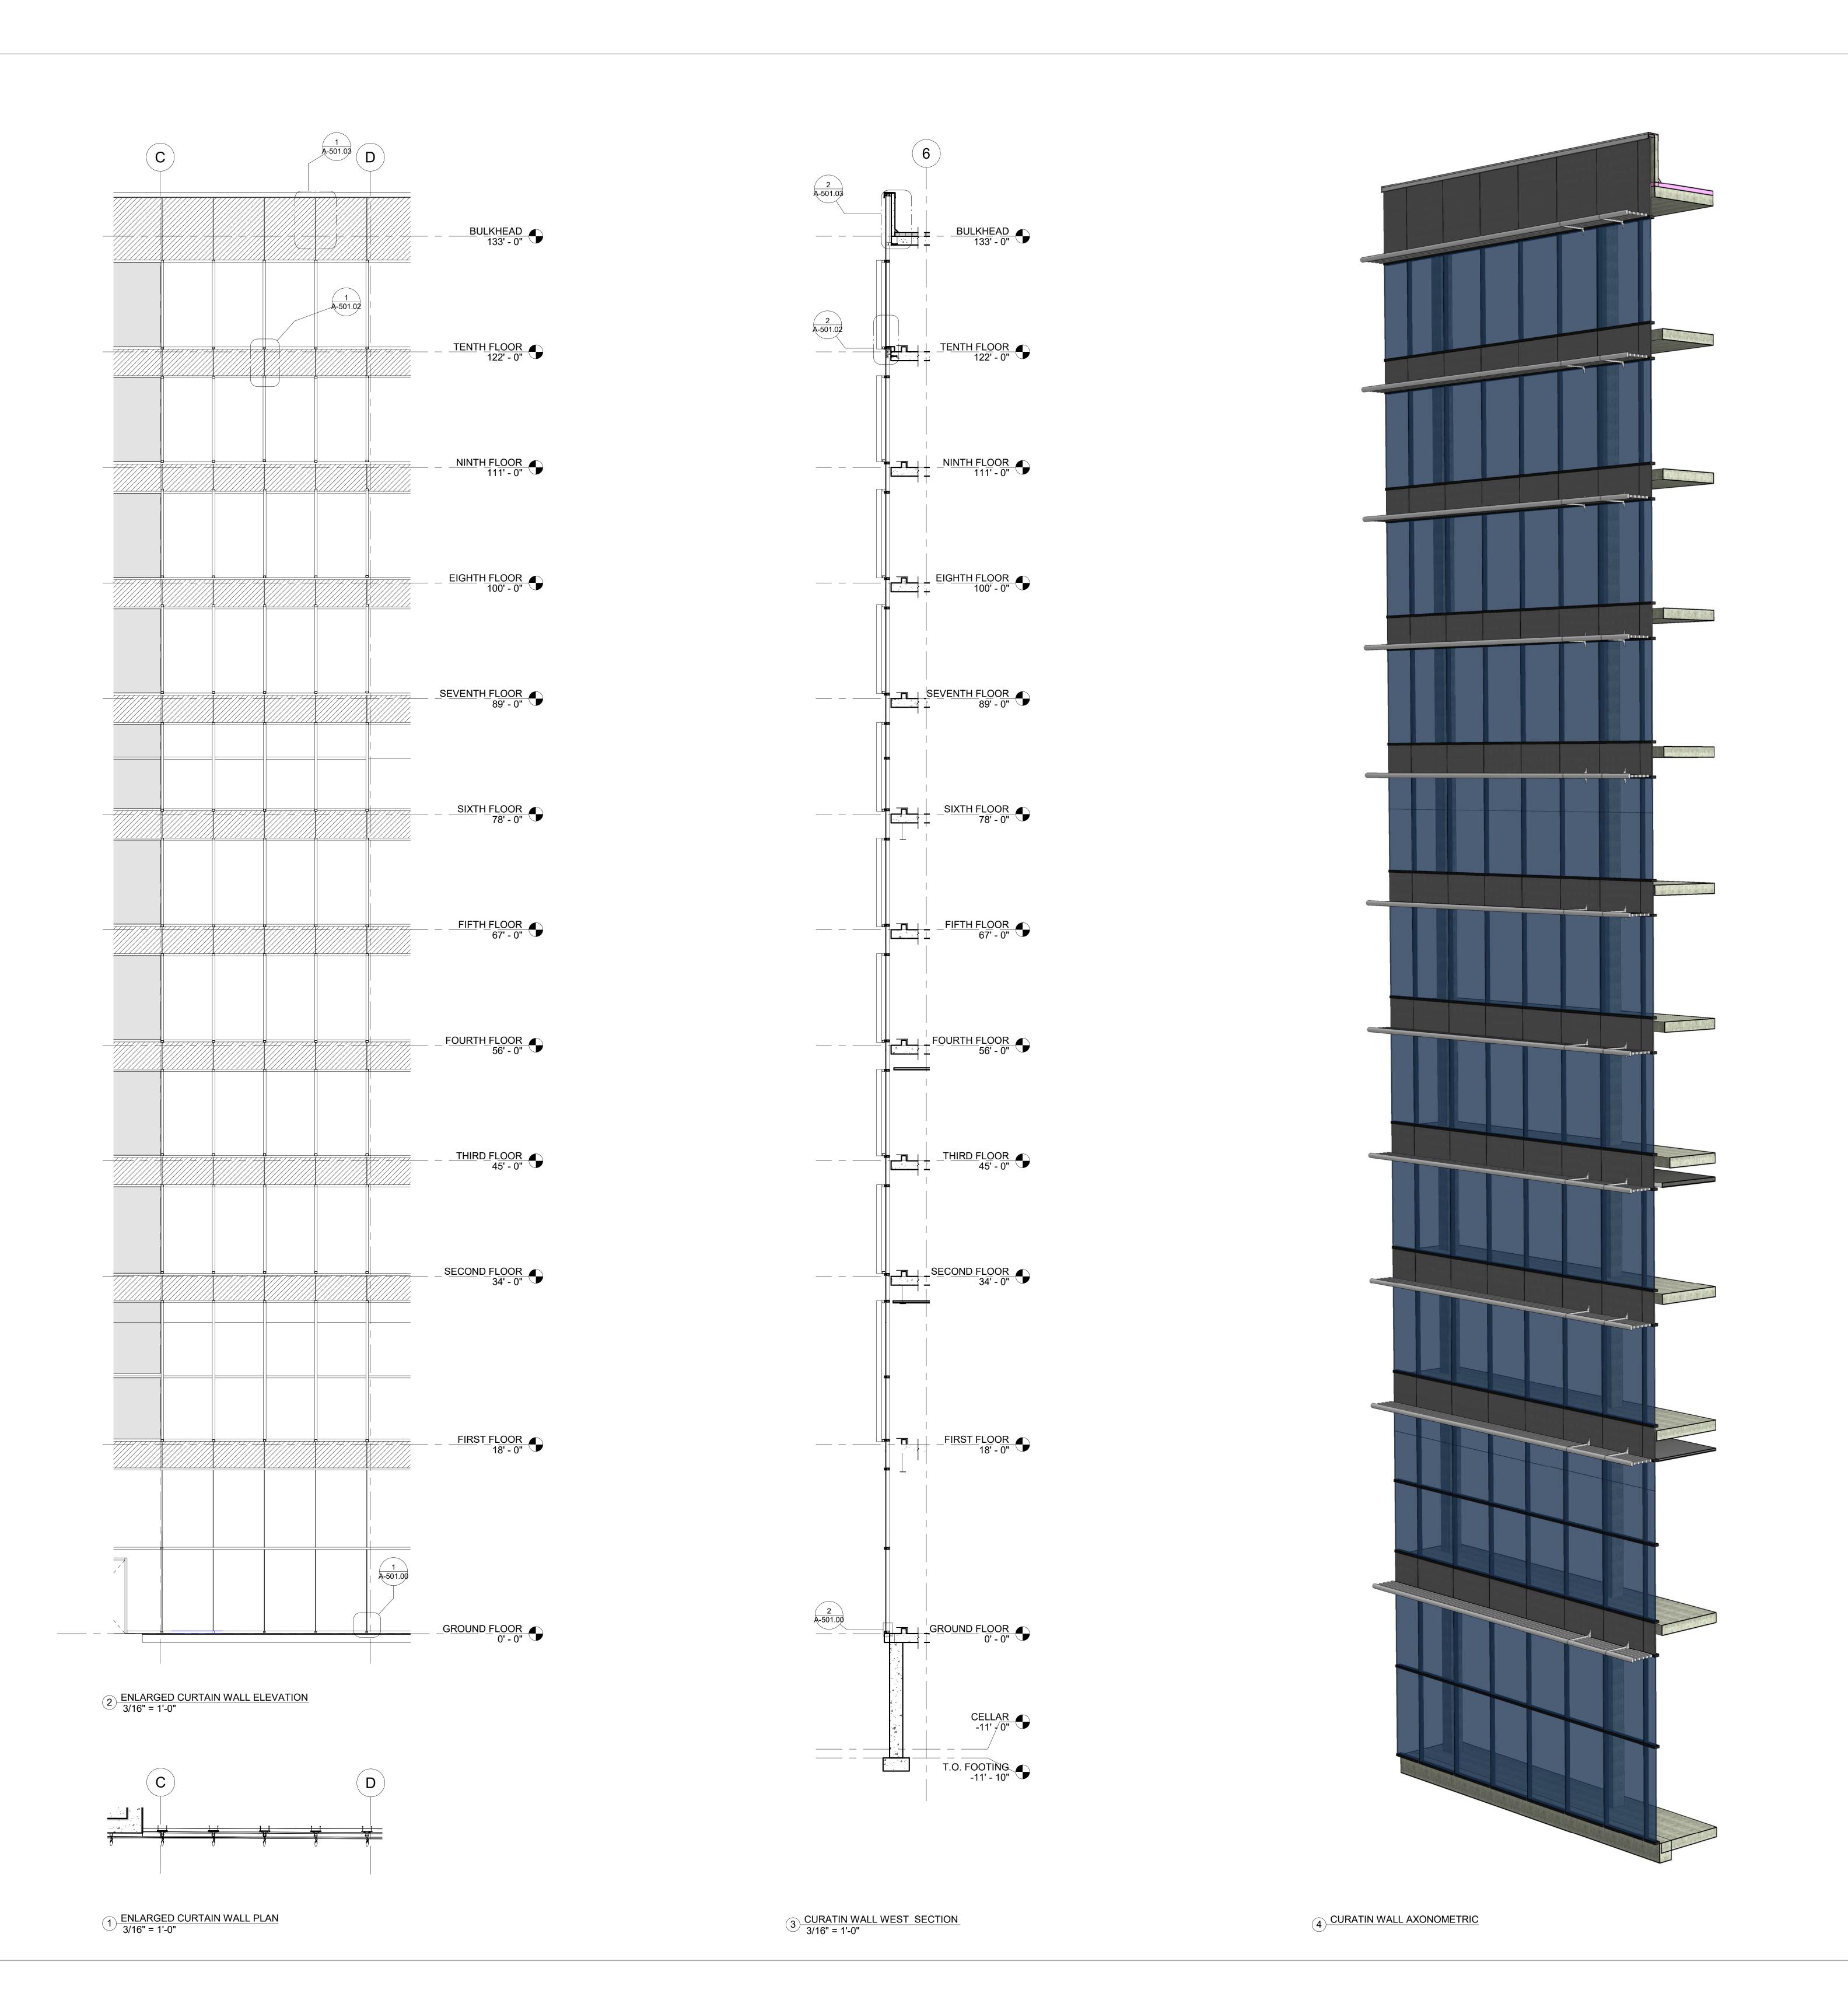
RYAN SINGH

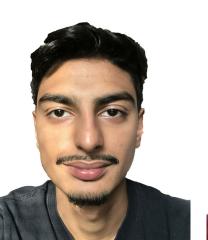1 JOHN STREET

EXPLODED BUILDING DIAGRAM

- 1	I	
	Project Number	Project Number
	Date	Issue Date
	Drawn By	AQIB BHATT
	Checked By	Checke


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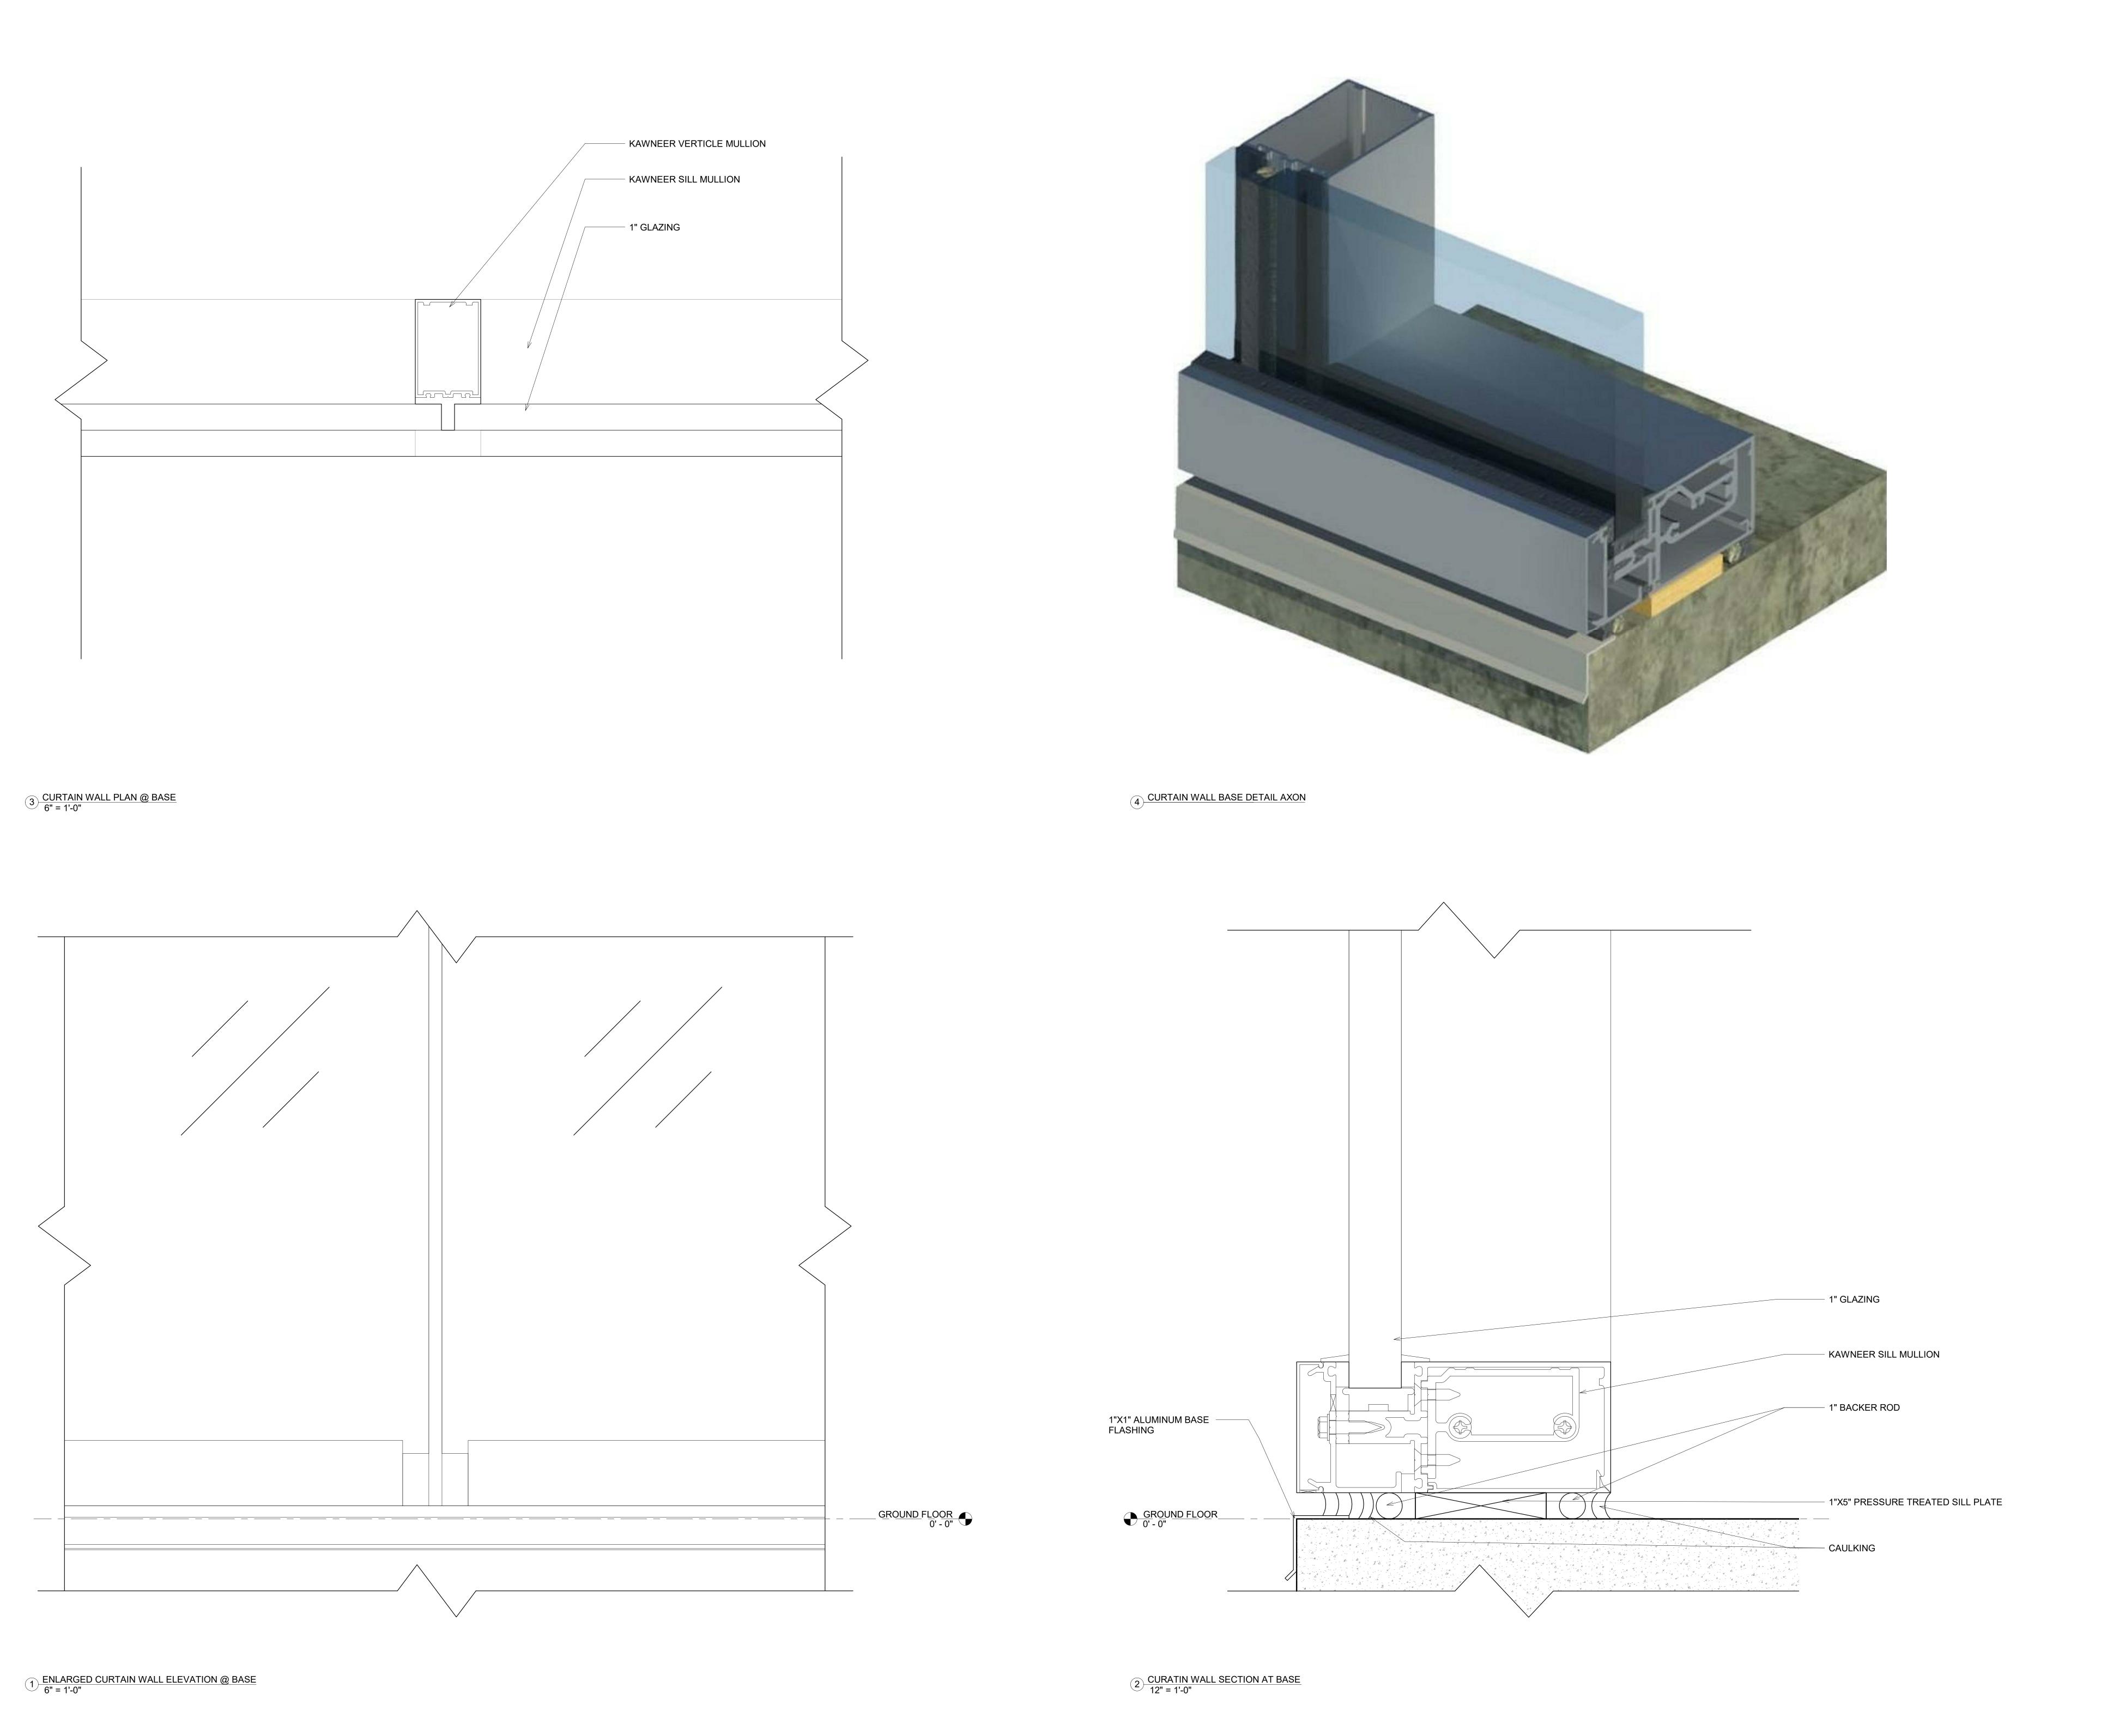
RYAN SINGH

1 JOHN STREET

ENLARGED CURTAIN WALL **ELEVATION-WALL** SECTION

Project Number	Project Number
Date	Issue Dat
Drawn By	RYAN SINGI
Checked By	Checke

A-500.00

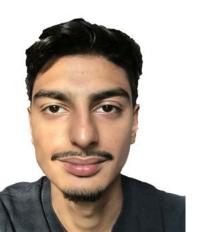




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AQIB BHATTI


RYAN SINGH

1 JOHN STREET

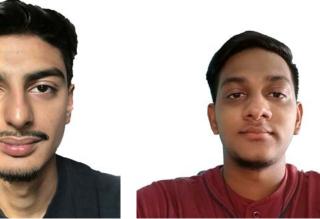
CURTAIN WALL DETAILS @ BASE

	Project Number	Project Number
	Date	Issue Date
	Drawn By	AQIB BHATTI
	Checked By	Checker


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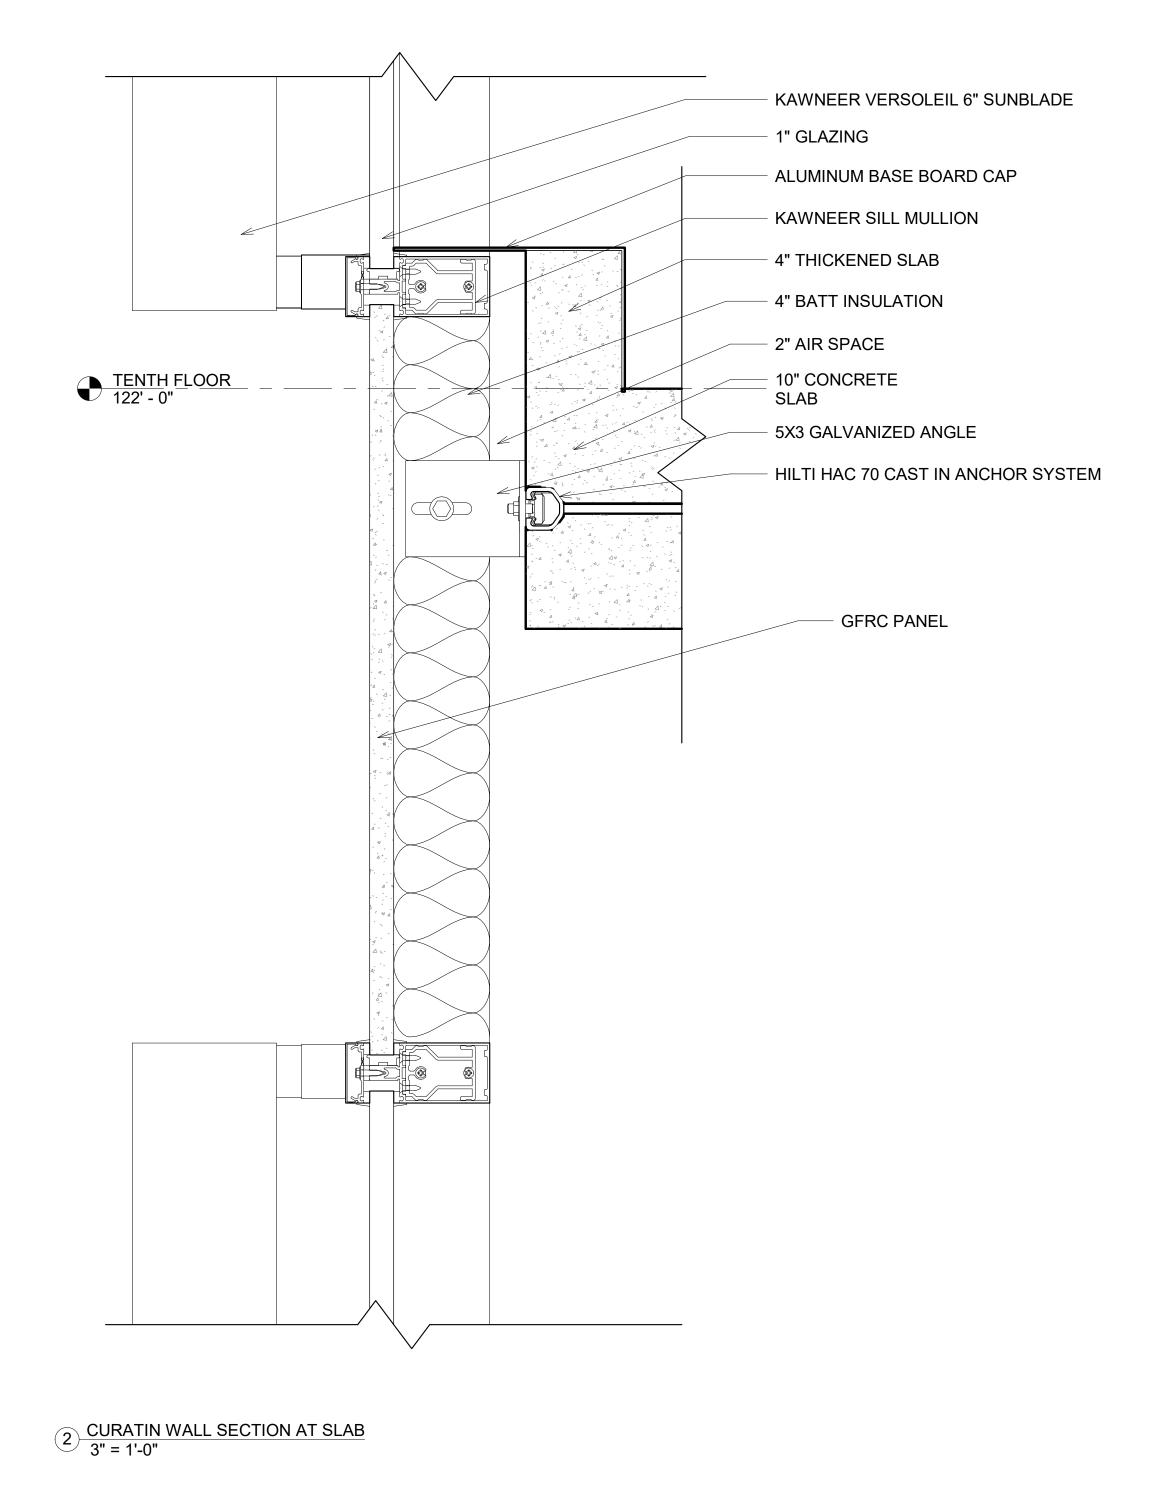


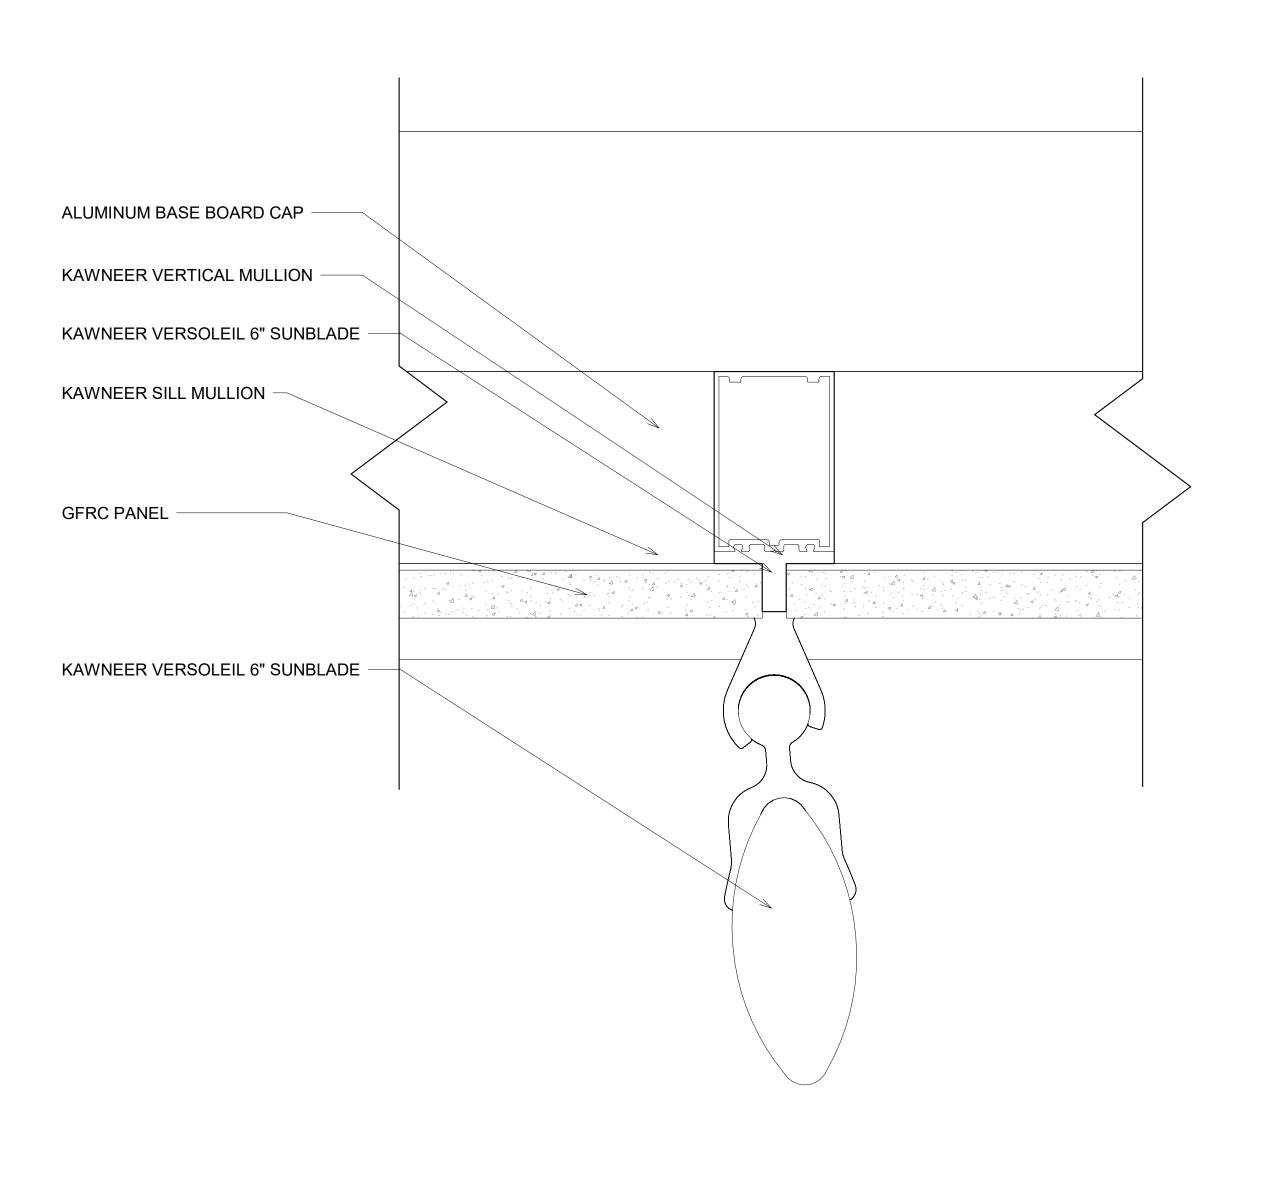3 CURTAIN WALL PLAN @SLAB 6" = 1'-0"

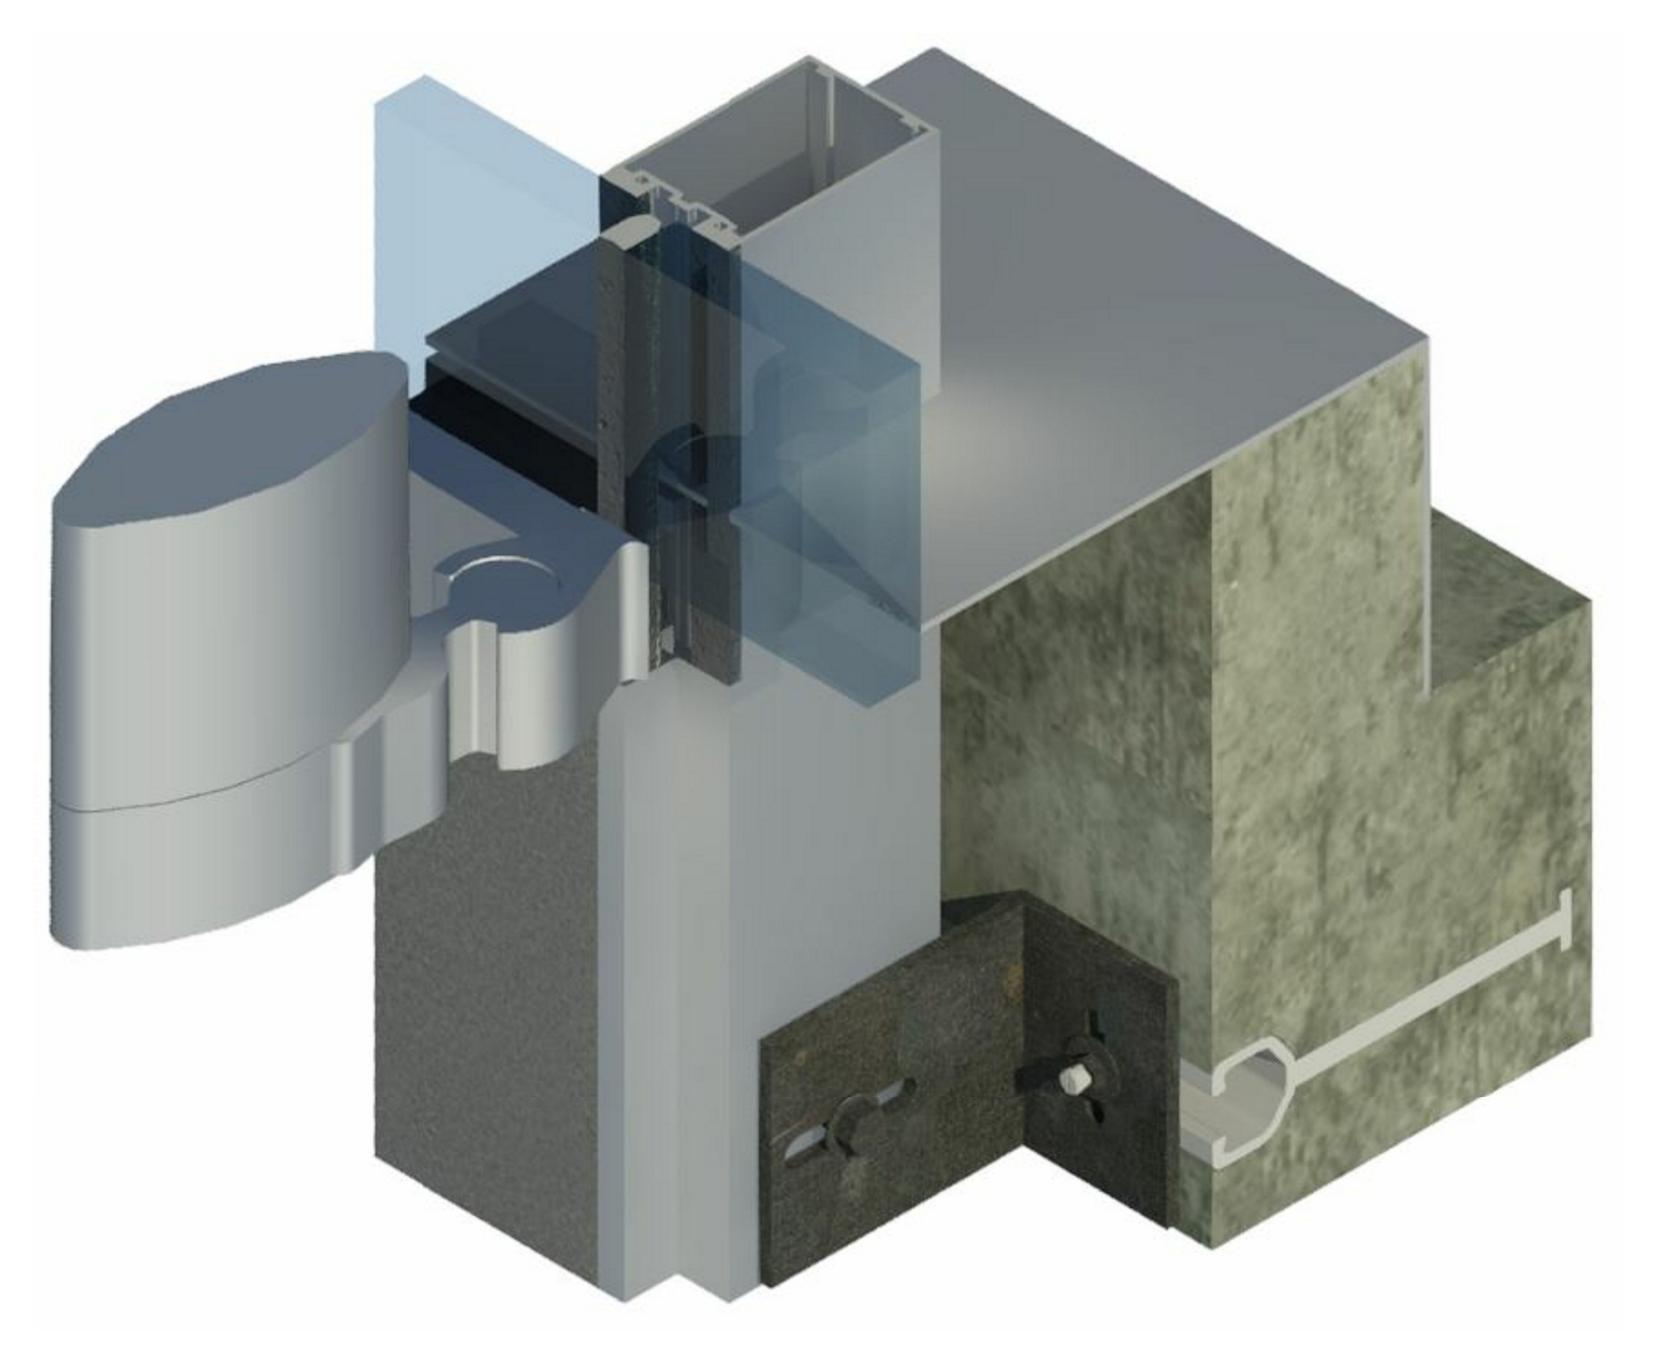

4 CURTAIN WALL CONNECTION AT SLAB



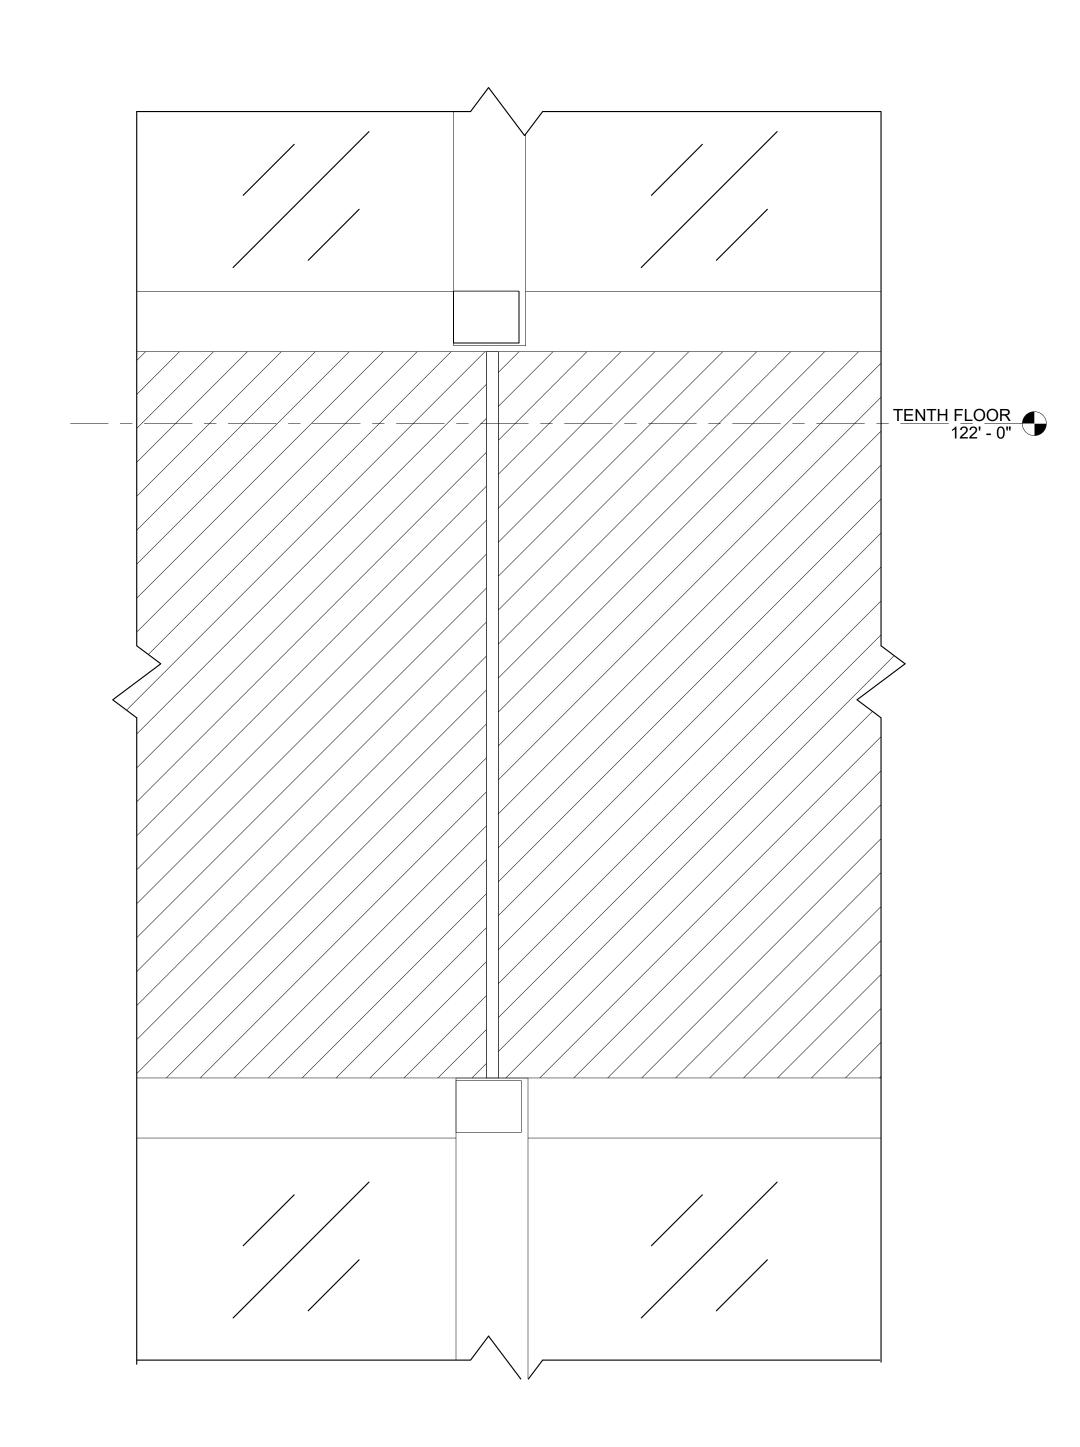

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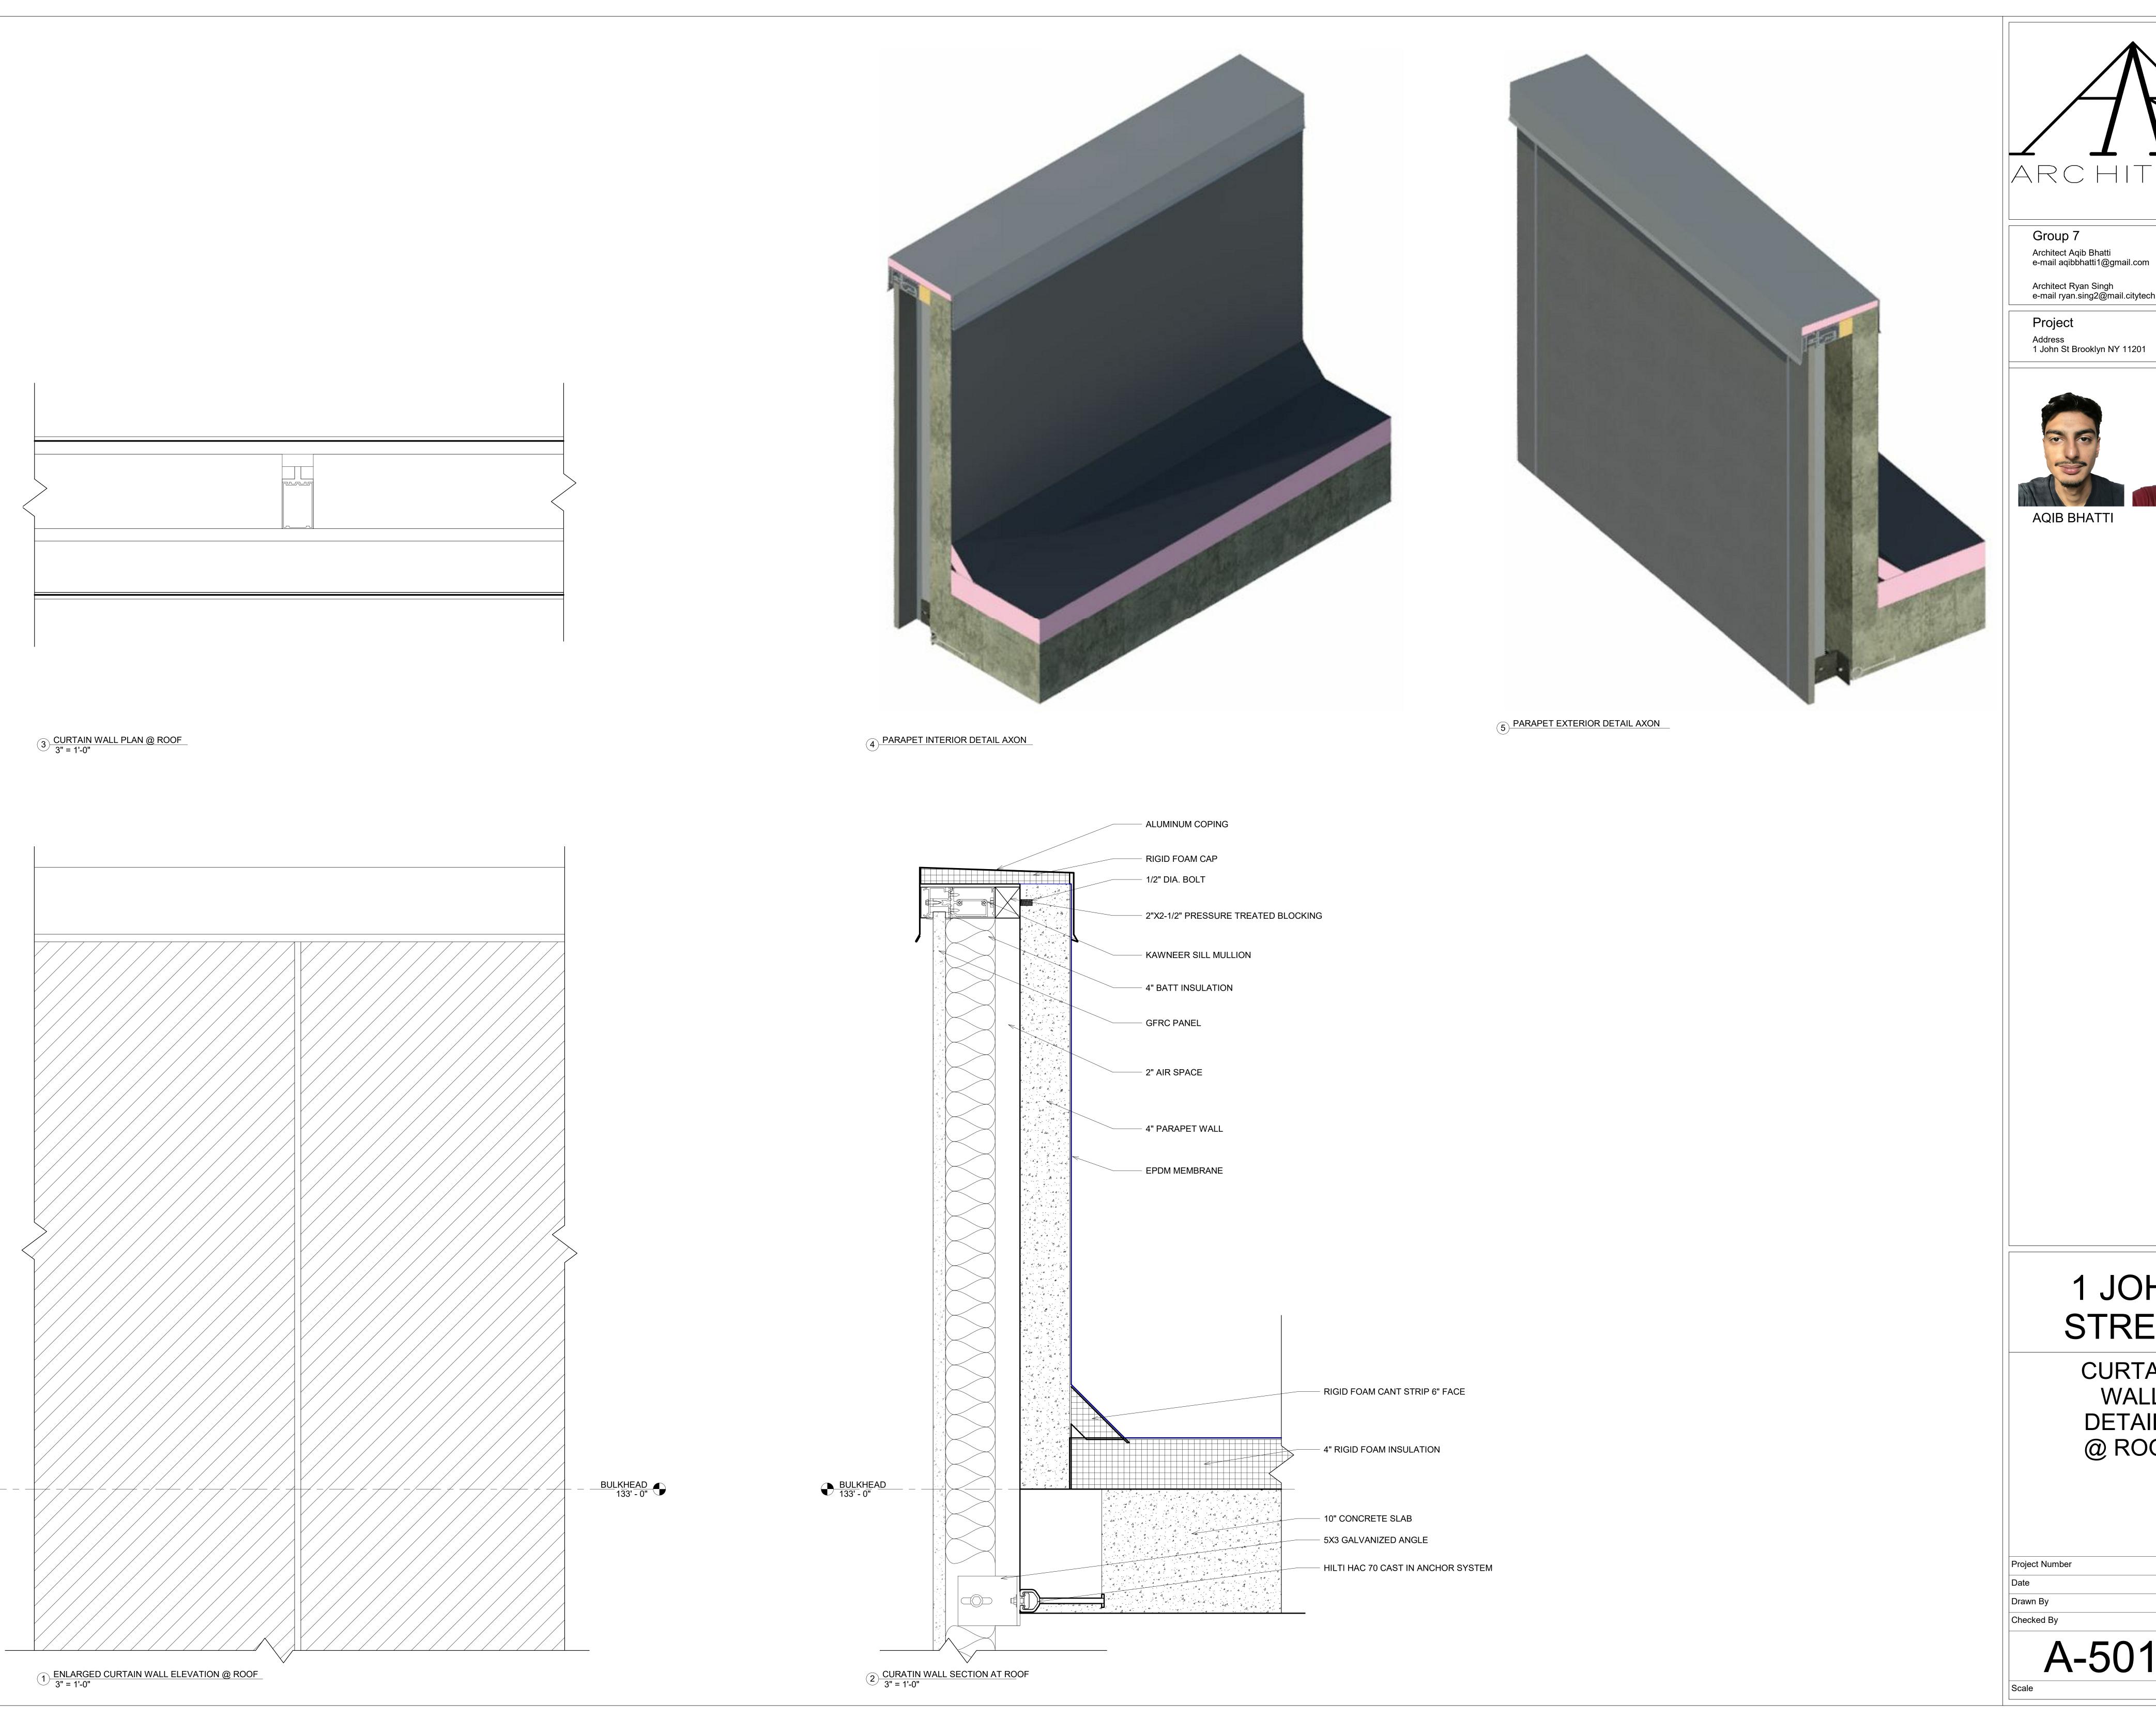
RYAN SINGH

1 JOHN STREET

CURTAIN WALL DETAILS @ SLAB


	Project Number	Project Number
	Date	Issue Date
	Drawn By	AQIB BHATTI
	Checked By	Checker

A-501.01





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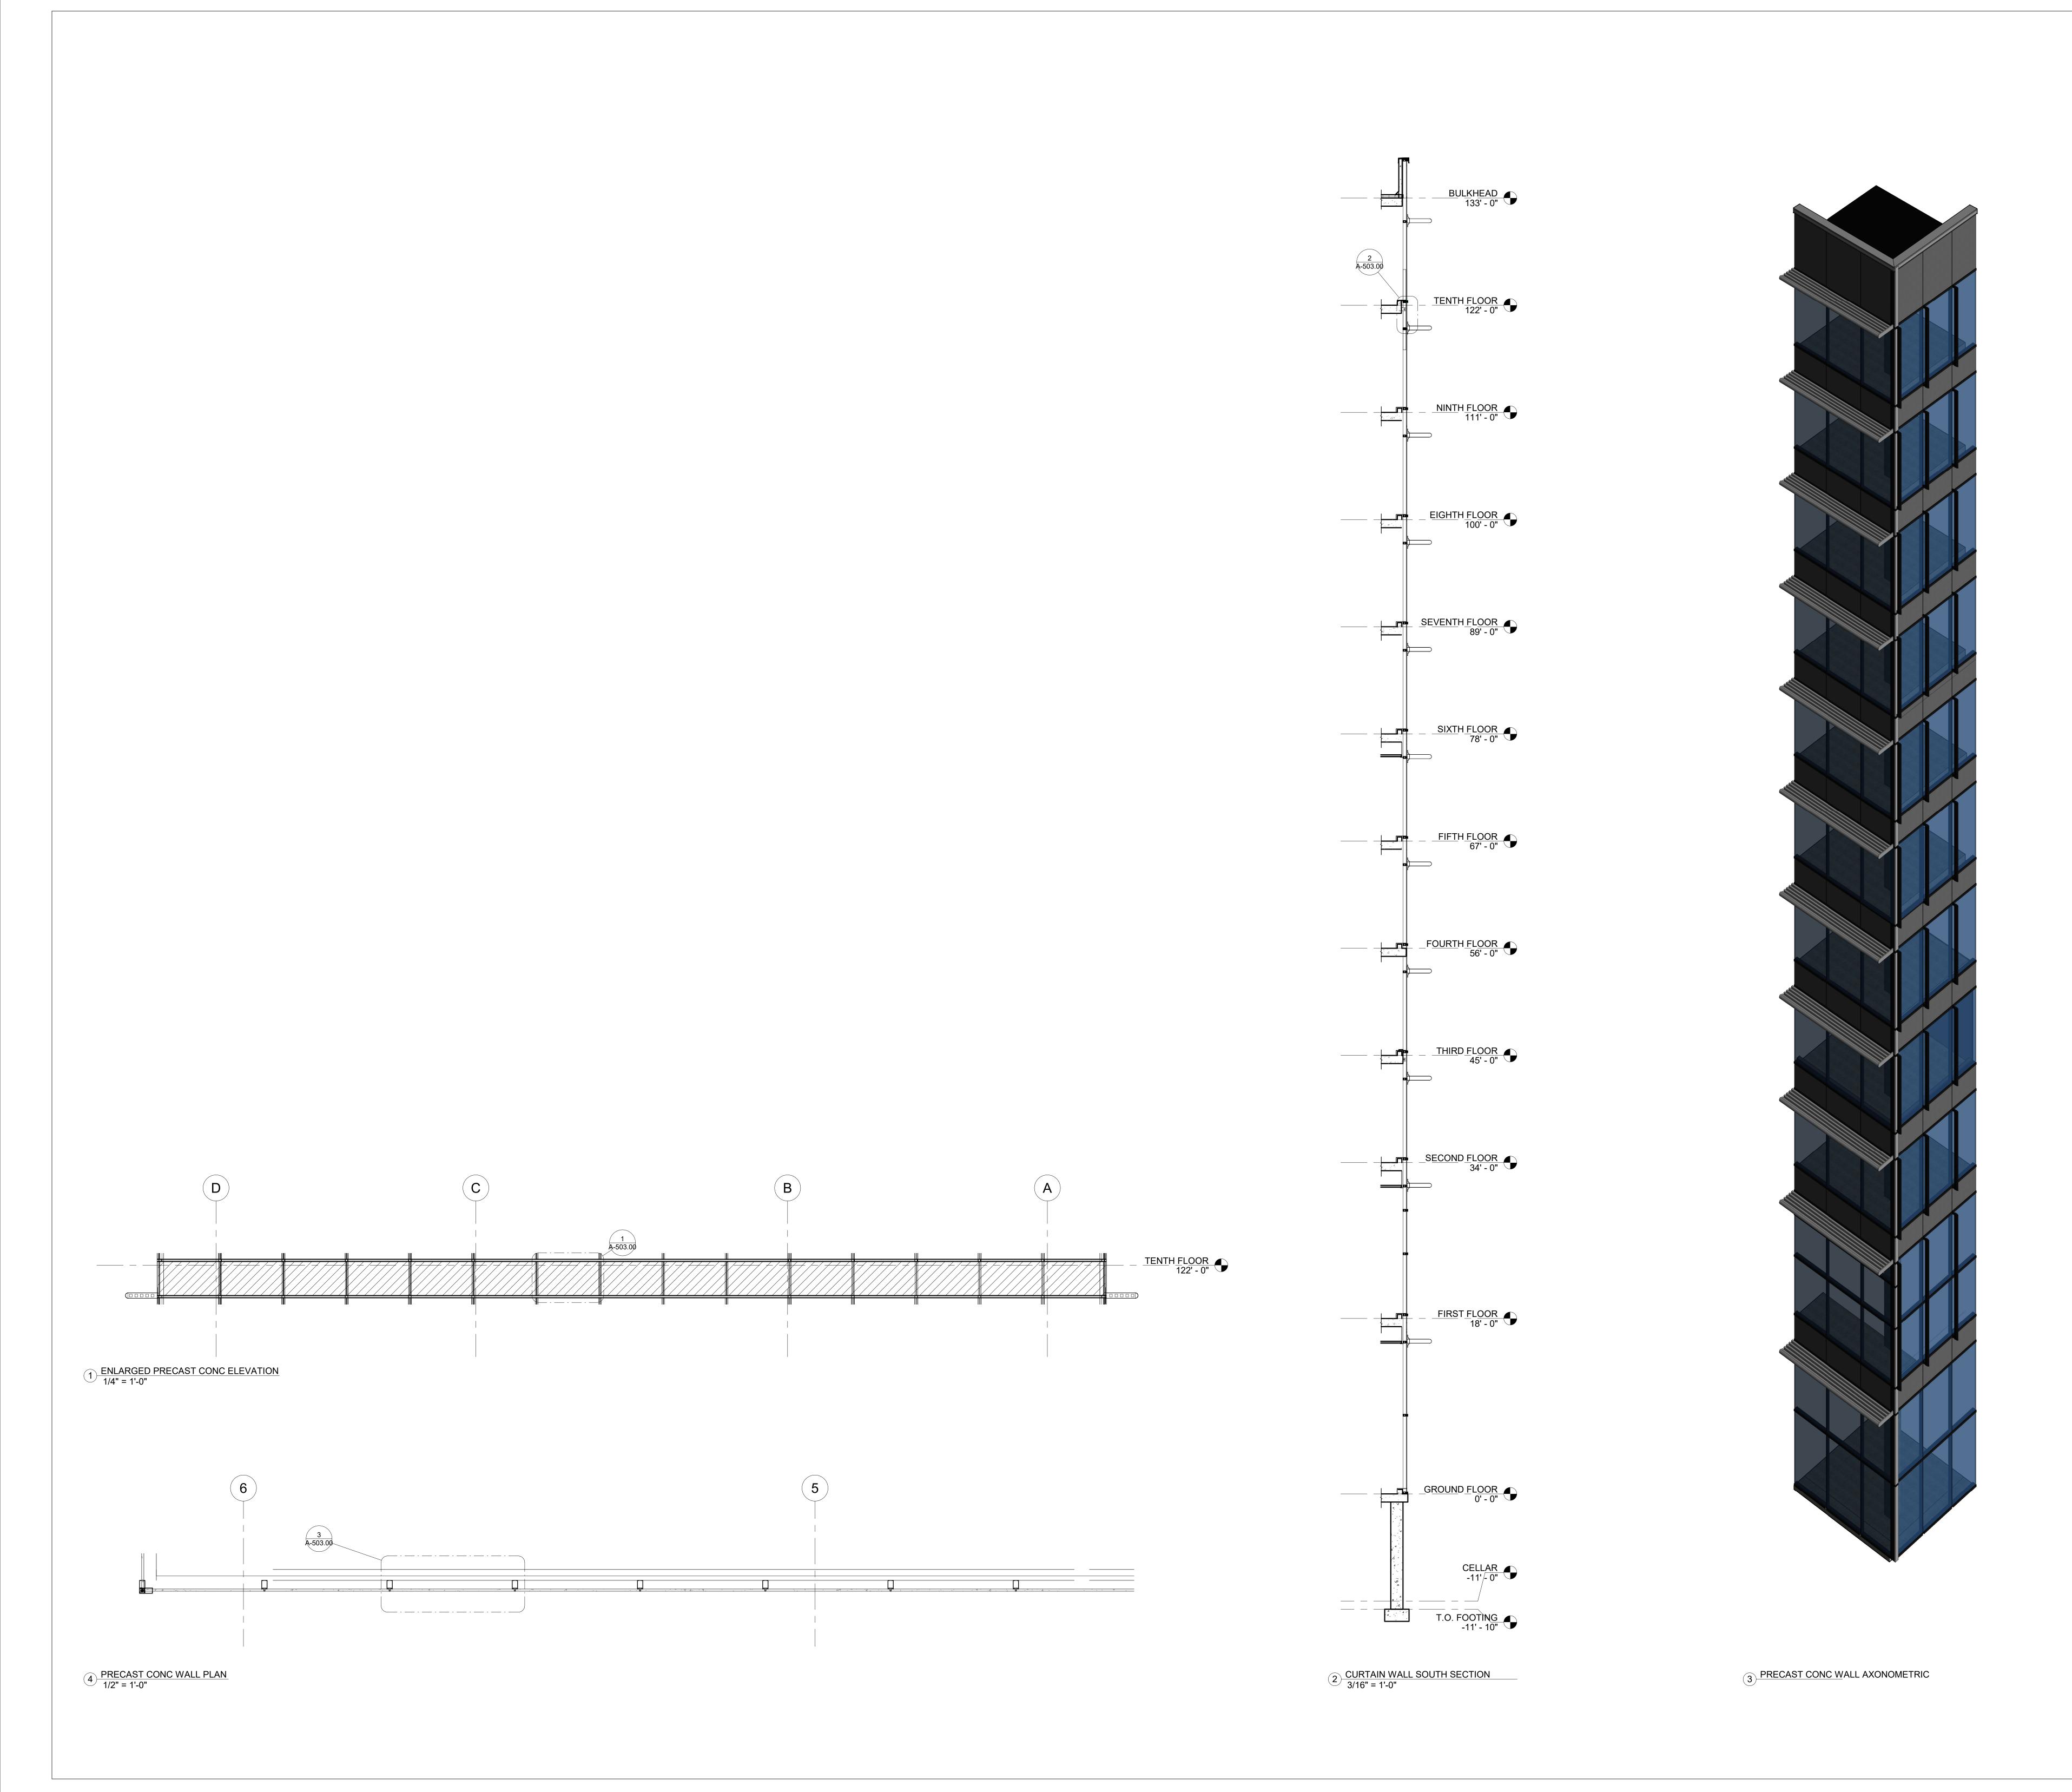
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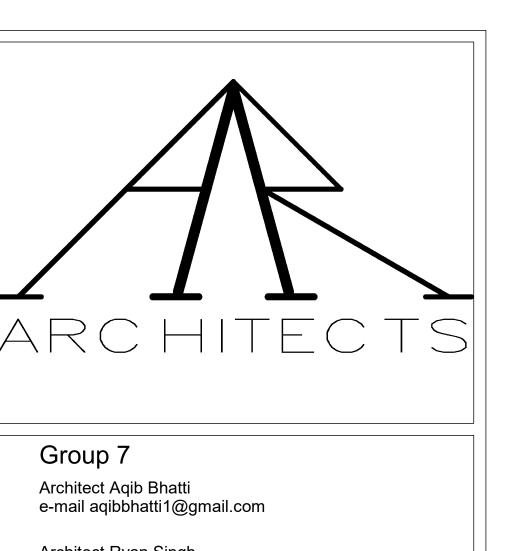
1 JOHN STREET

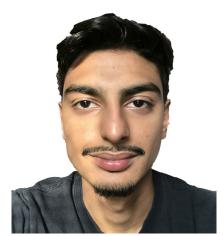CURTAIN WALL DETAILS @ ROOF

Project Number	Project Number
Date	Issue Date
Drawn By	AQIB BHATTI
Checked By	Checker


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AQIB BHATTI


RYAN SINGH

1 JOHN STREET


ENLARGED PRE CAST CONC. **ELEVATION** + WALL SECTION

Project Number	Project Number
Date	Issue Date
Drawn By	RYAN SINGH
Checked By	Checker

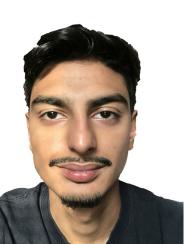
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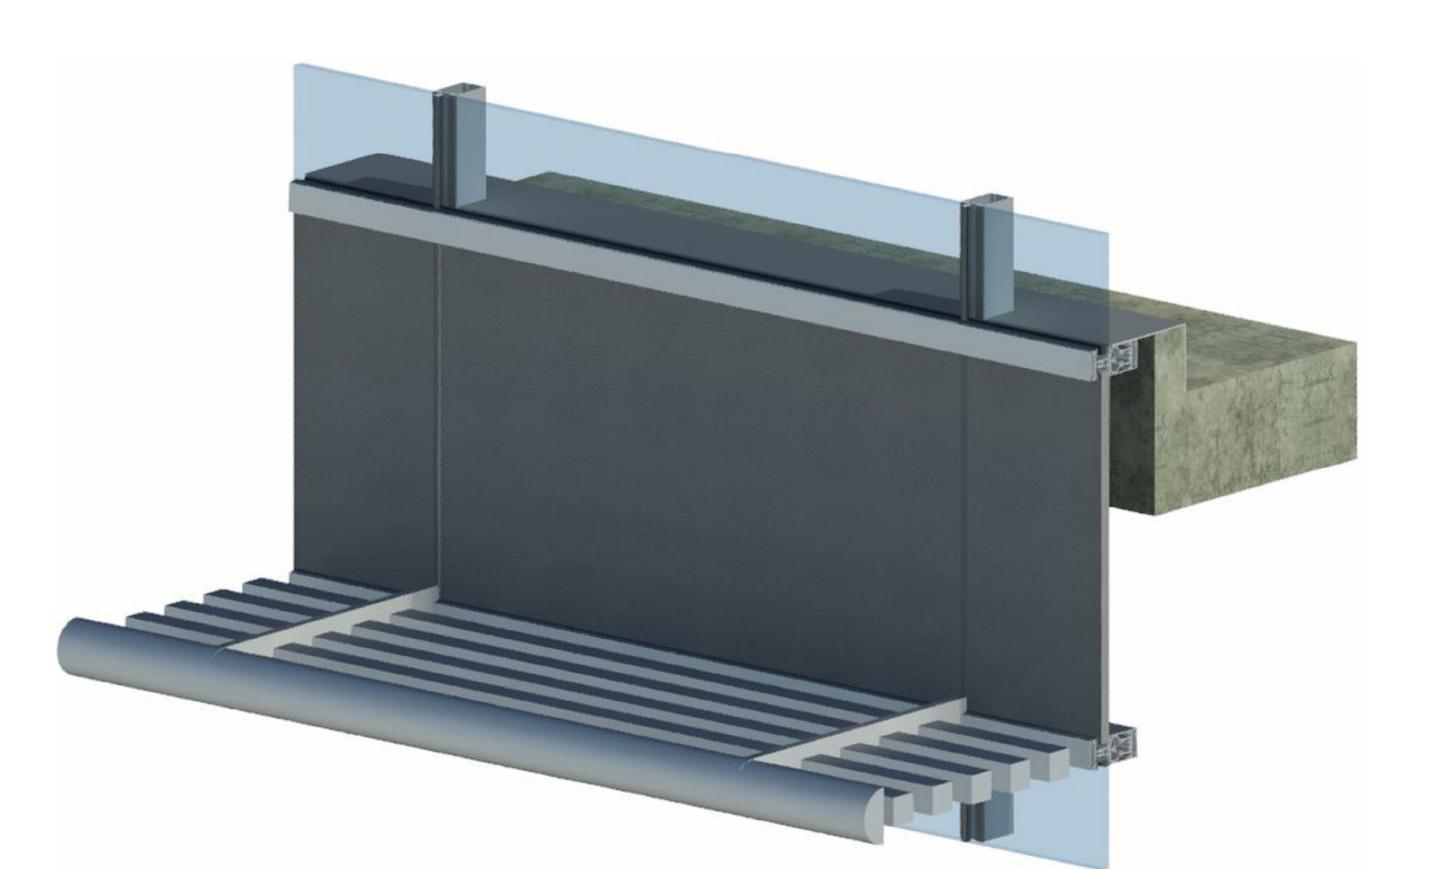


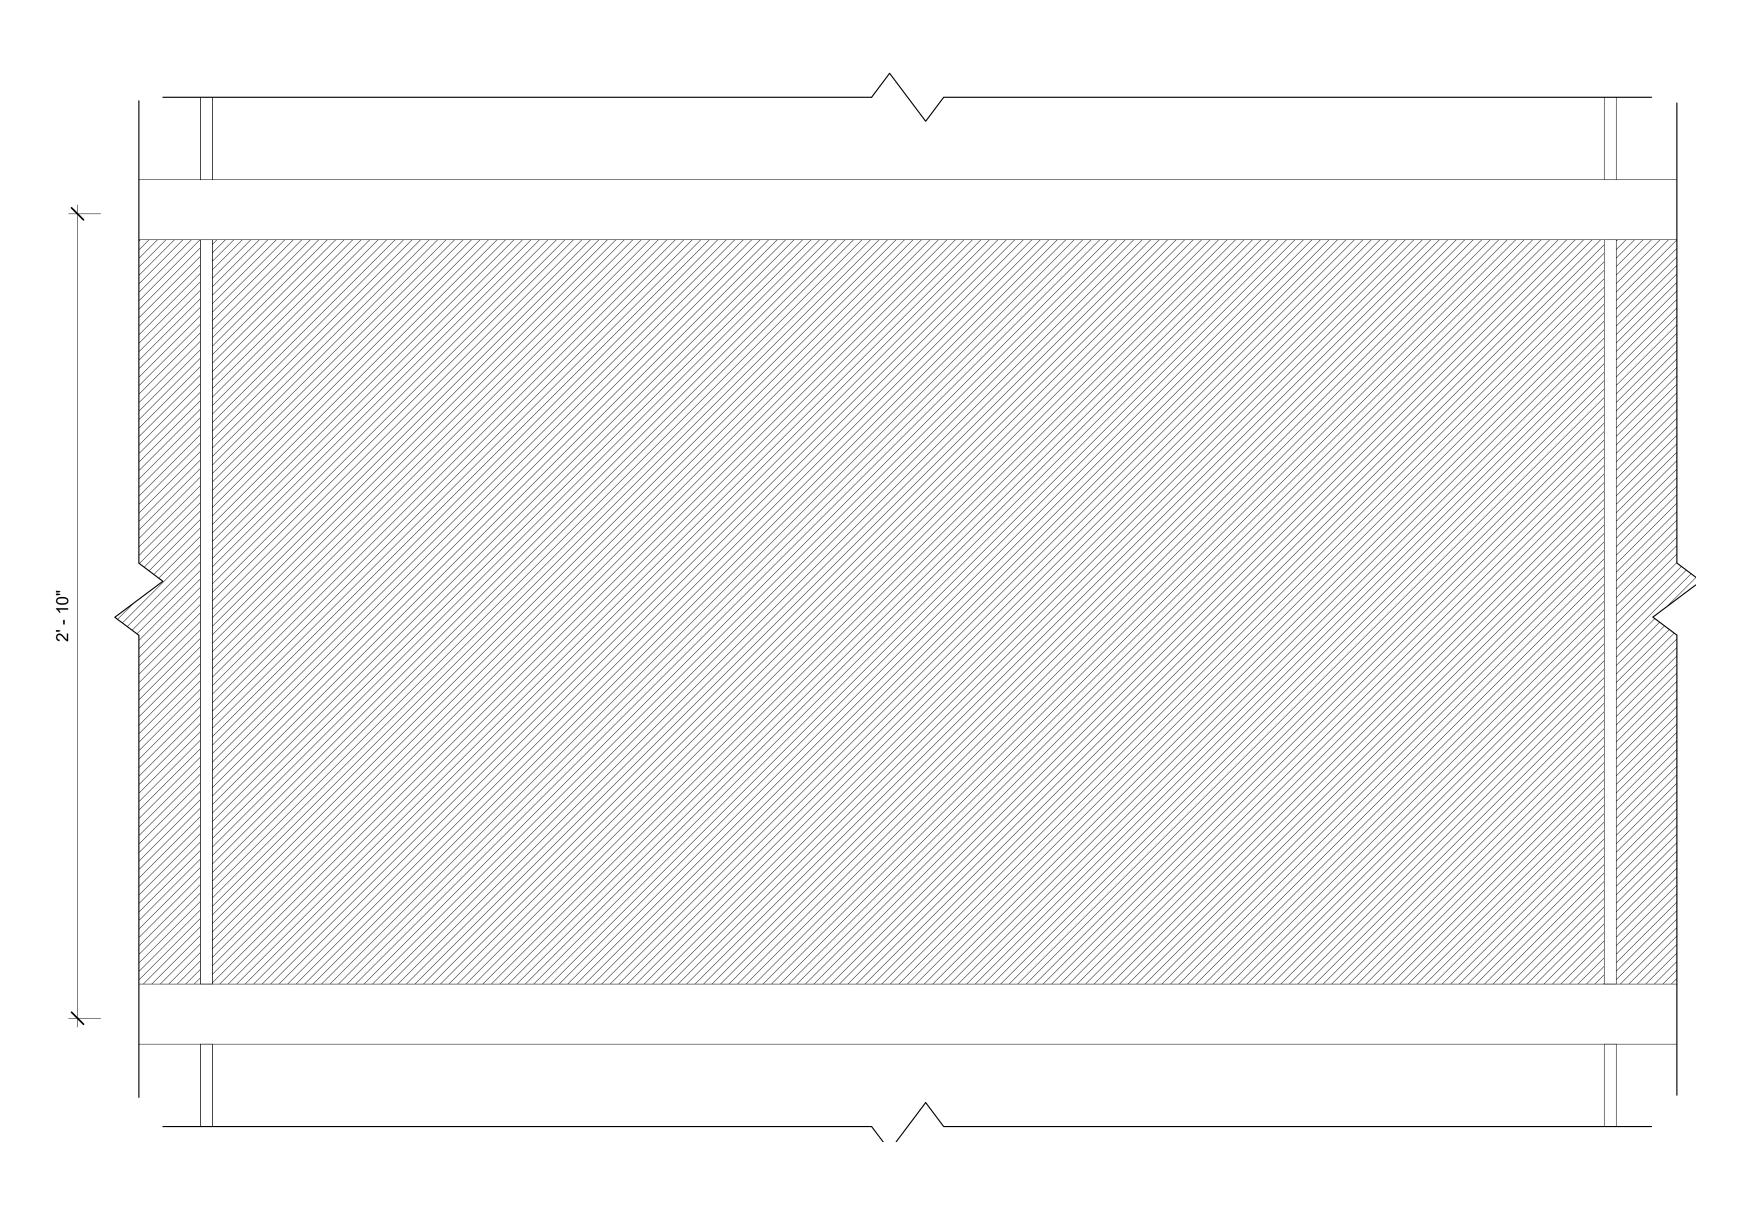

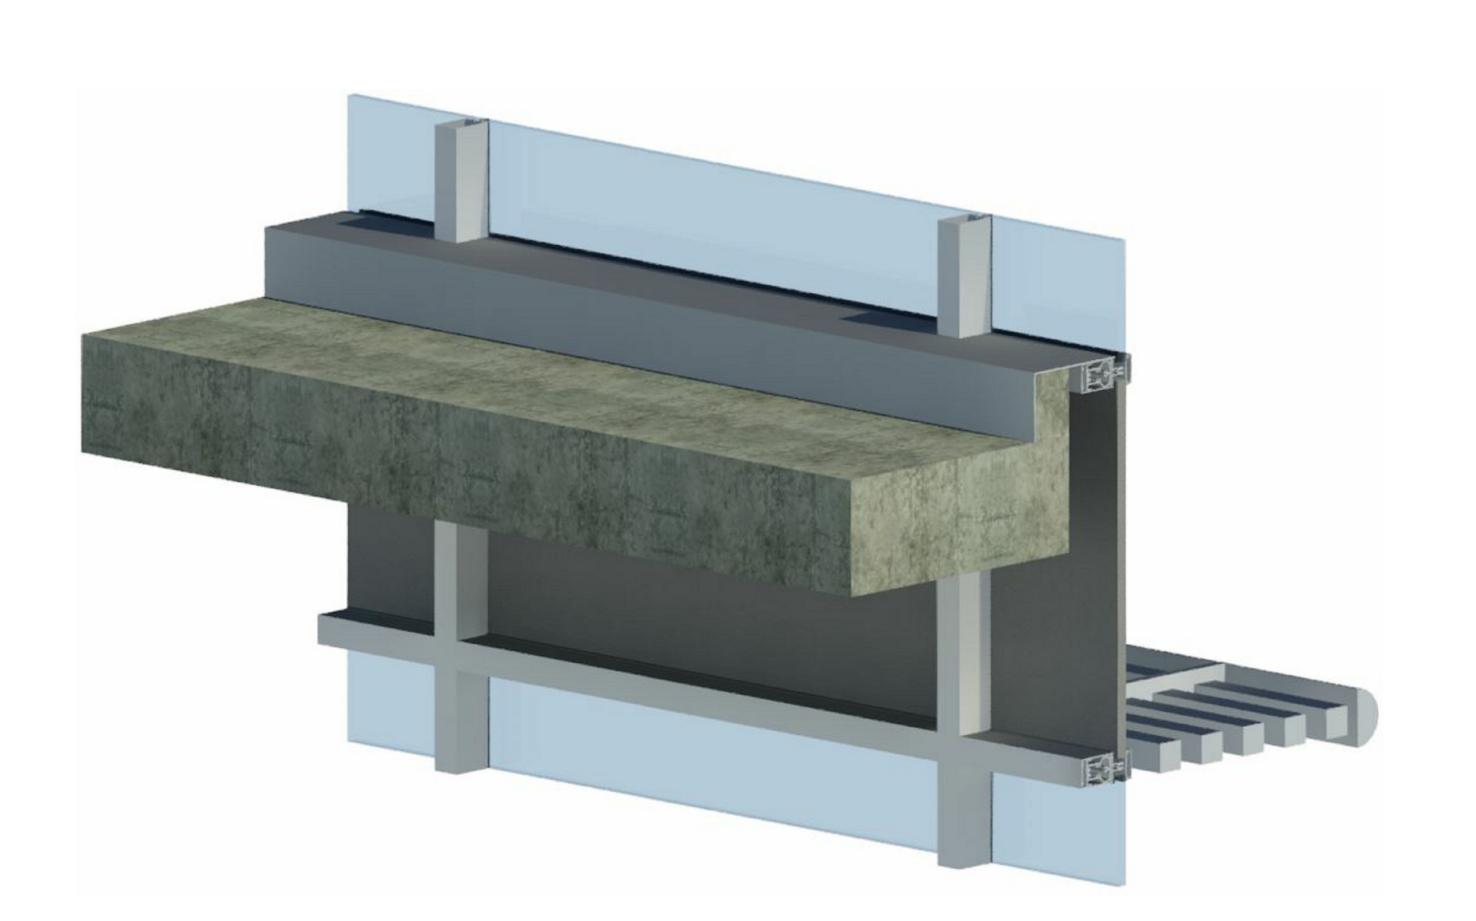

(5) PRECAST CONC. INTERIOR DETAIL



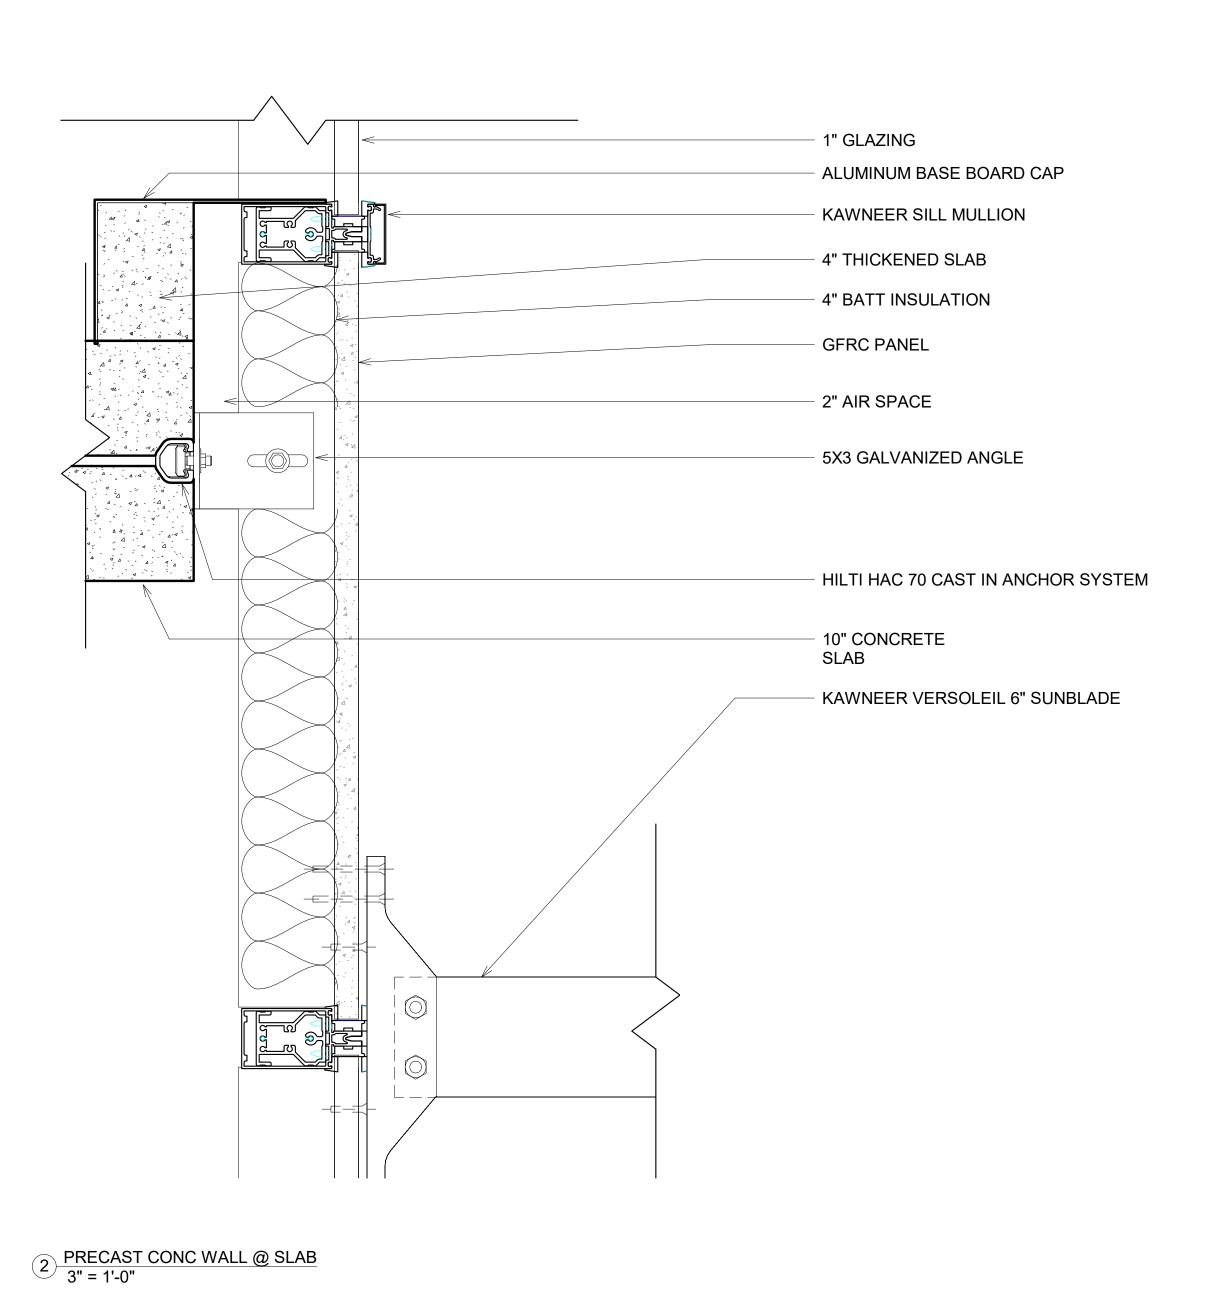

4 PRECAST CONC. EXTERIOR DETAIL



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RYAN SINGH


1 JOHN STREET

PRECAST CONCRETE DETAILS

Project Number	Project Number
Date	Issue Date
Drawn By	AQIB BHATTI
Checked By	Checker

A-503.00


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AQIB BHATTI

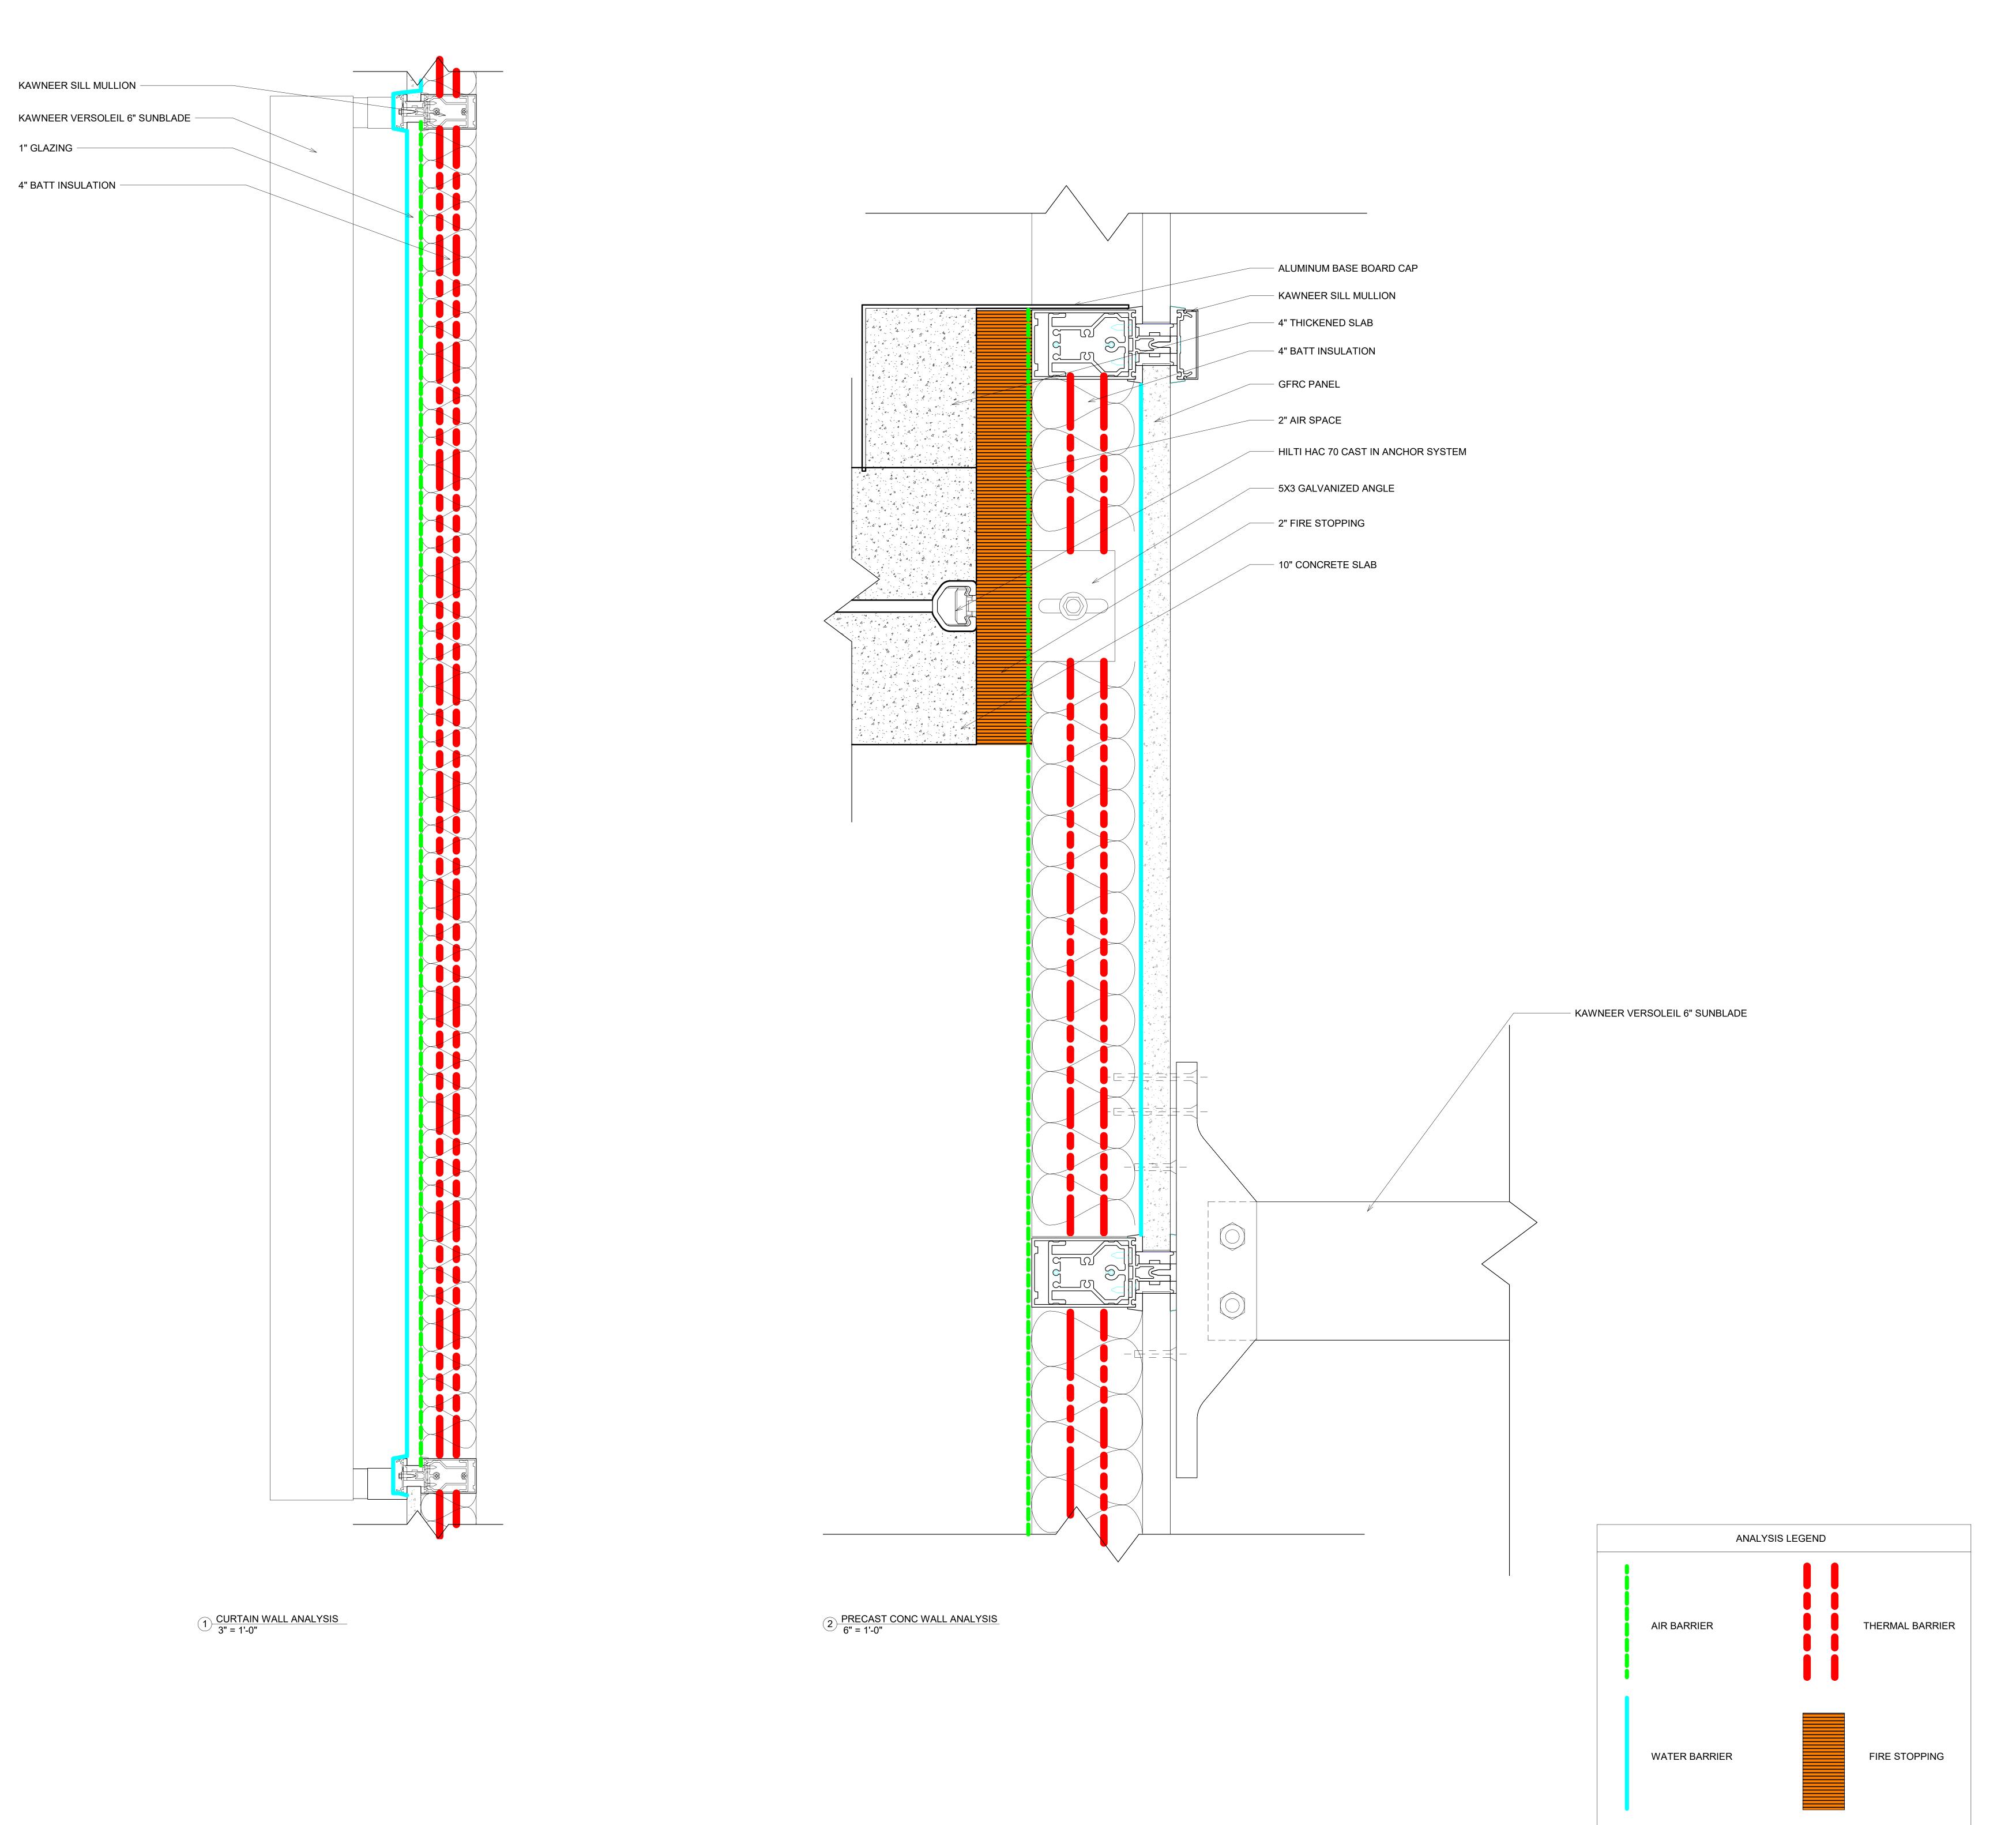
RYAN SINGH

1 JOHN STREET

CURTAIN WALL + PRECAST CONCRETE ANALYSIS

Project Number	Project Number
Date	Issue Date
Orawn By	RYAN SINGH
Checked By	Checker

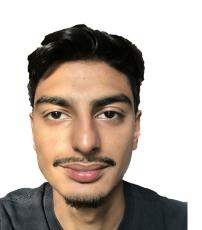A-504.00

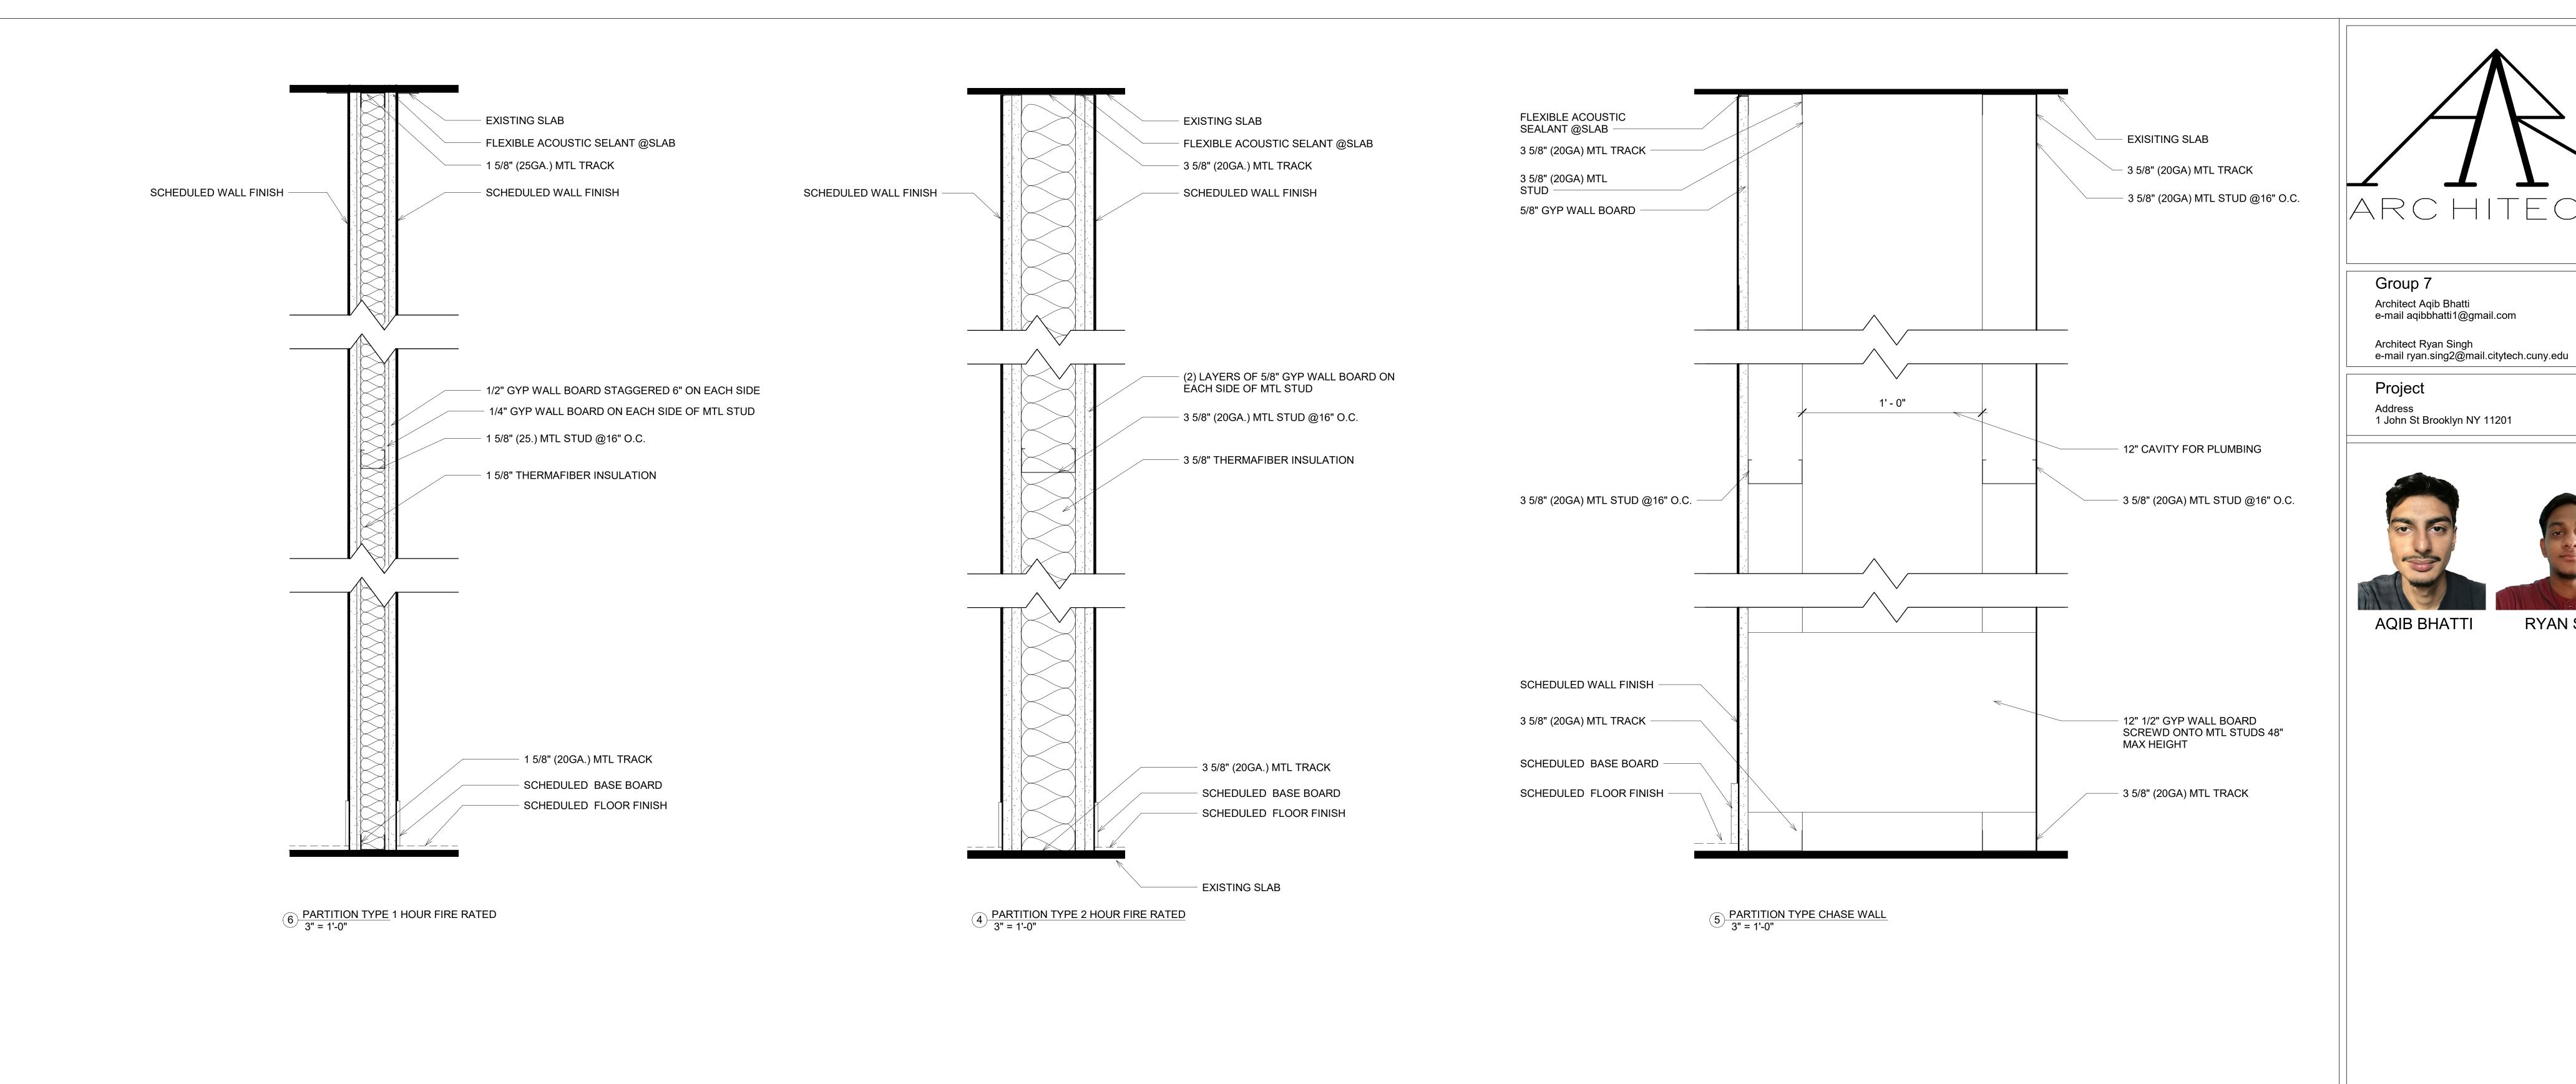

EXISTING SLAB

SCHEDULED WALL FINISH -

WATERPROOF MEMBRANE

2" RIGID INSULATION BOARD R=10

INSULATED SLOPE CANT STRIP

#8 BAR STEEL REINFORCEMNT @7" O.C. #3 BAR STEEL REINFORCEMNT ELBOW

30"X15" BEARING FOOTING

- 4" PERFORATED DRAINING PIPE

GRAVEL BACKFILL

- #3 REBAR ELBOW TYP.

- SCHEDULED WALL FINISH

5/8" GYPSUM WALL BOARD

7/8" METAL FURRING @16" O.C.

#3 BAR STEEL REINFORCEMENT

5/8" GYPSUM WALL BOARD


11,000 PSI 15" CAST IN PLACE CONCRETE

#6 BAR STEEL REINFORCEMENT @16" O.C.

- #3 BAR STEEL REINFORCEMENT @16" O.C.

- #6 BAR STEEL REINFORCEMENT

FLEXIBLE ACOUSTIC SELANT @SLAB

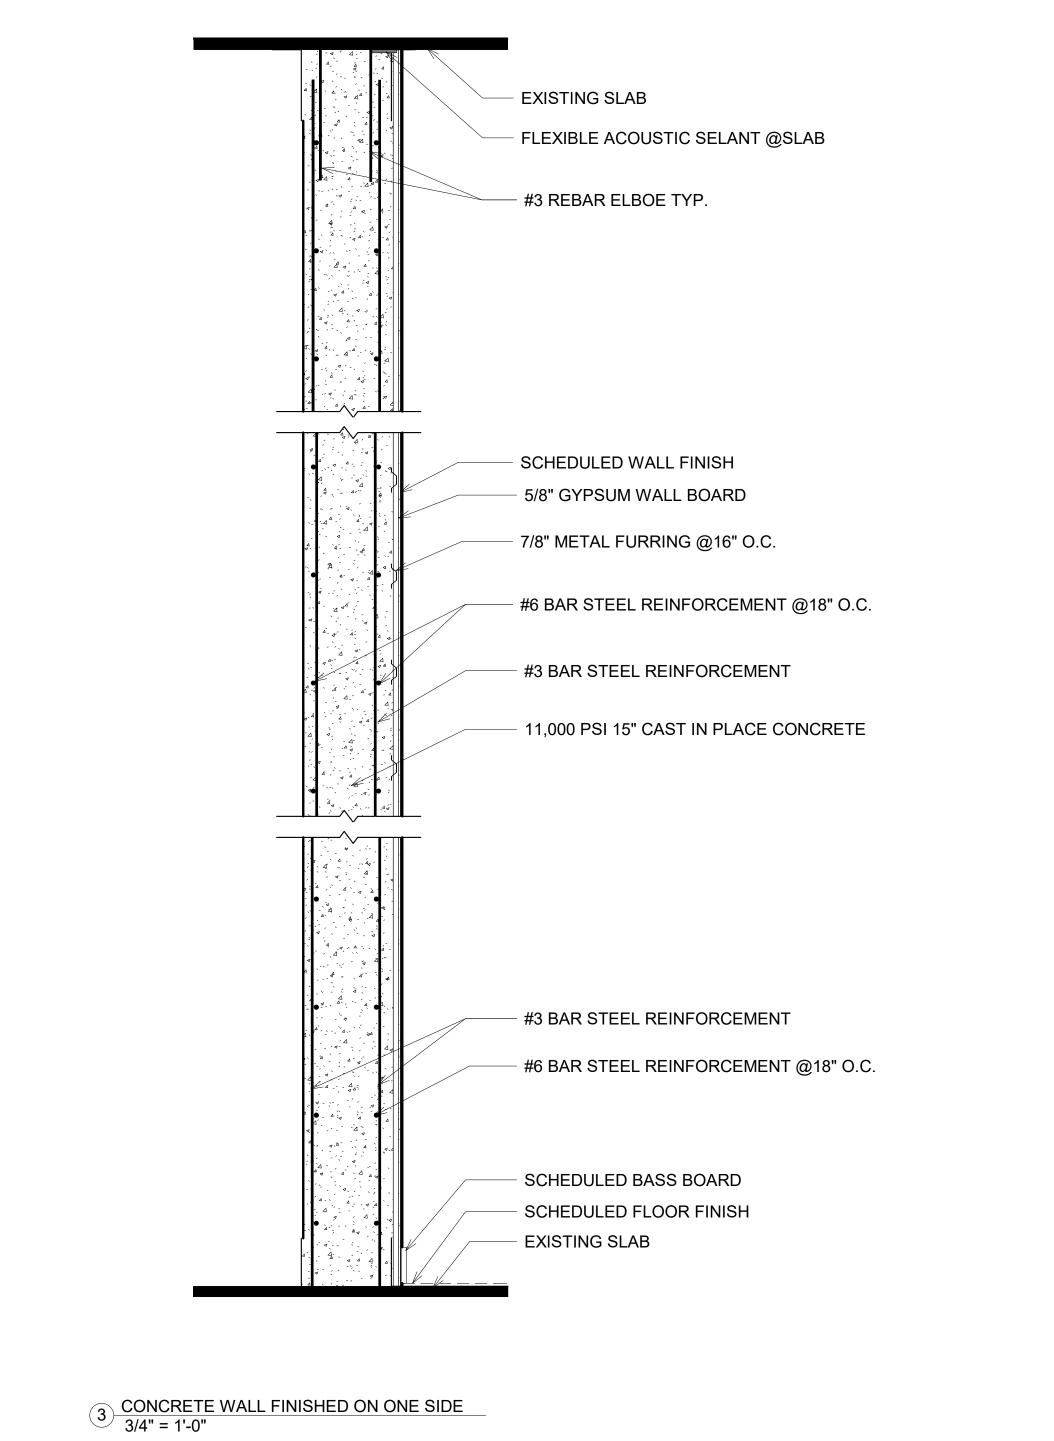

1 JOHN STREET PARTITION **TYPES**

RYAN SINGH

Project Number Project Number Issue Date RYAN SINGH Drawn By Checker Checked By

A-505.00

1 FOUNDATION WALL TYPE 1 1/2" = 1'-0"

EXISTING SLAB -

#8 BAR STEEL REINFORCEMENT @18" O.C.

15" POURED CONCRETE WALL 11,000 PSI

#8 BAR STEEL REINFORCEMENT @18" O.C.

#8 BAR STEEL REINFORCEMENT

10" POURED CONCRETE FLOOR SLAB

1/2" EXPANSION JOINT

20 MIL VAPOR RETARDER


4" FINE GRANDULATED SAND -

2" RIGID INSULATION -

4" COURSE GRAVEL -

#8 BAR STEEL REINFORCEMENT

2 CONCRETE WALL FINISHED ON BOTH SIDES 3/4" = 1'-0"

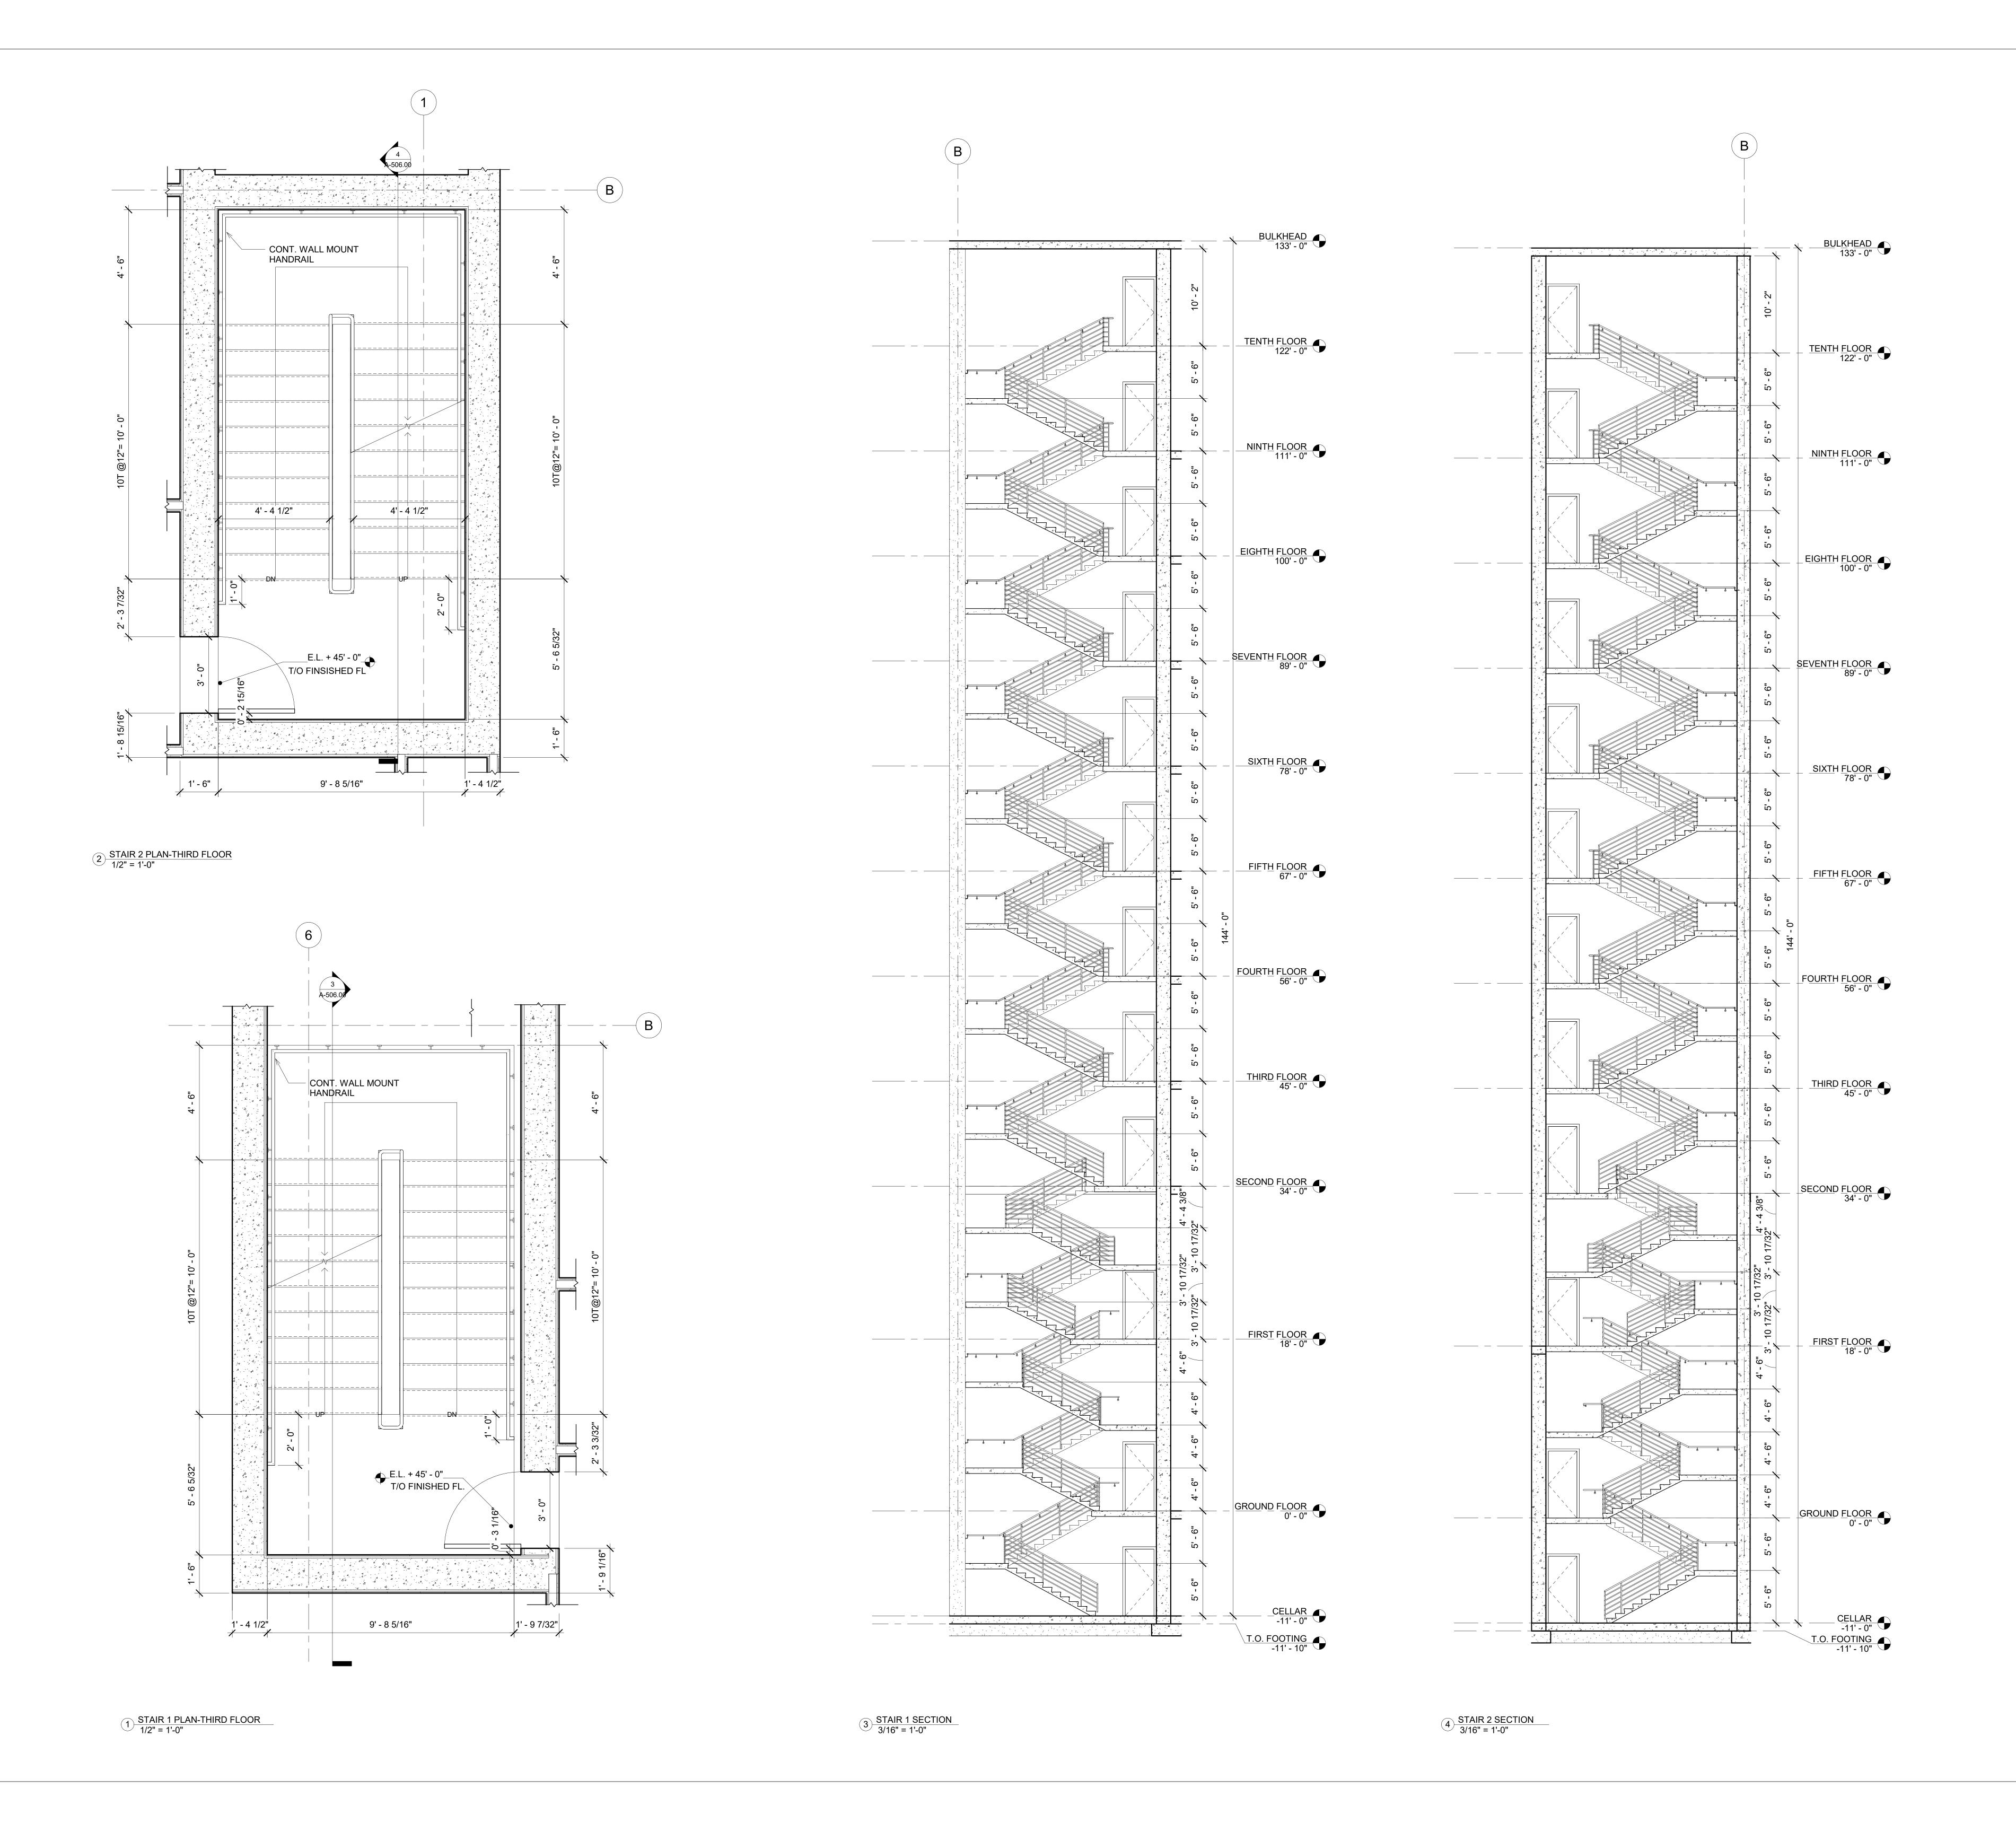



Architect Ryan Singh e-mail ryan.sing2@mail.citytech.cuny.edu

Project
Address
1 John St Brooklyn NY 11201





AQIB BHATTI

RYAN SINGH

1 JOHN STREET

ENLARGED
STAIR
PLANS
AND
SECTIONS

roject Number	Project Number
ate	Issue Date
rawn By	RYAN SINGH
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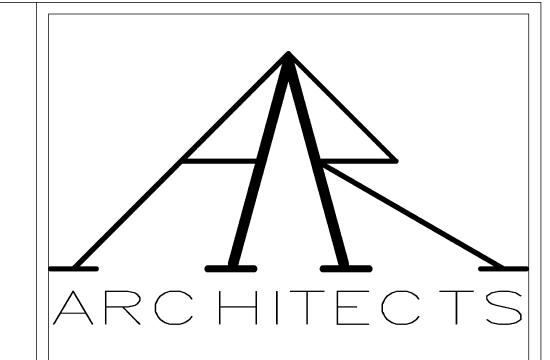
DIVISION 03-CONCRETE 03 11 00-CONCRETE FORMING 03 11 13-STRUCTURAL CAST IN PLACE CONRETE FORMING PART 1. GENERAL 1.1 SUMMARY Forming members for structural members such as foundation walls, isolated footings, spread footing, columns, stairs, and slabs PART 2. PRODUCTS PAR 2.2 MANUFACTURES Any company capable and licensed to do so. 2.3 DESCRIPTION PAR Formwork must be of timber construction 2.4 PERFORMANCE/DESIGN CRITERIA Timber performance based on engineers calculations 2.6 MATERIALS ASSEMBLY OR FABRICATION Formwork assembled on site PART 3. EXECUTION 3.2 EXAMINATIONS Formwork must be verified to be free of defects and properly braced 3.3 PREPERATIONS Release agent must be applied to form work 3.4 ERECTION/INSTALLATION/APPLICATION Verify all reinforcing members are correct. Build up formwork according to engineers plans. 03 11 13.13-CONCRETE SLIP FORMING PART 1. GENERAL 1.1 SUMMARY 03 3 All shafts will be slipped formed PART 2. PRODUCTS 2.2 MANUFACTURES Any company capable and licensed to produce product PART 2.3 DESCRIPTION Forms must be as per drawings 2.4 PERFORMANCE/DESIGN CRITERIA Hoisting Machines must be per engineers calculations and approval 2.6 MATERIALS ASSEMBLY OR FABRICATION Slip Form assembled on site PART 3. EXECUTION 3.2 EXAMINATIONS All items must be inspected they are able to execute requirements PART 3.3 PREPERATIONS All hoisting assemblies must be checked they are in operating status. Formwork must be checked before every 3.4 ERECTION/INSTALLATION/APPLICATION Setup all hoisting assemblies and form work in correct location. Verify all reinforcing members are correct. Do a slump test to verify concrete is to standards. Pour concrete into formwork. Vibrate formwork to release air pockets. After concrete is cured lift formwork with hoist. Verify formwork is usable for next pour. Repeat process 03 15 00-CONCRETE ACCESSORIES 03 15 19-CAST IN ANCHORS PART 1. GENERAL 1.1 SUMMARY Cast in anchors embedded in face of slab. 03 49 PART 2. PRODUCTS PAR 2.2 MANUFACTURES HILTI 2.3 DESCRIPTION PART HILTI HAC 70 Cast in anchor HILTI HBC-C-N Bolts 2.4 PERFORMANCE/DESIGN CRITERIA Pass ASTM E488 / E488M-18 2.7 MIXES AND FINISHES Galvanized Finishes PART 3. EXECUTION 3.2 EXAMINATIONS

	Verify anchor is free of defects
	3.3 PREPERATIONS
	Secure to reinforcing members.
	3.4 ERECTION/INSTALLATION/APPLICATION
	Secure anchor to reinforcing members. After slab has cured, Remove protective foam from anchor.
21	00-REINFORCMENT BARS
21 :	13-GALVANIZED REINFORCMENT STEEL BARS
RT 1	GENERAL
	1.1 SUMMARY
	Reinforcing bars in concrete members
RT 2	PRODUCTS
	2.2 MANUFACTURES
	Any capable supplier
	2.3 DESCRIPTION
	Rebar sizes are as per drawings
	2.4 PERFORMANCE/DESIGN CRITERIA
	Up to ASTM A615 standards
	2.7 MIXES AND FINISHES
	Rebar to have galvanized coating.
RT 3	. EXECUTION
	3.2 EXAMINATIONS
	Rebar must not be damaged.
	3.4 ERECTION/INSTALLATION/APPLICATION
	Place rebar according to drawing. Verify rebar is securely tied.
31	00-STRUCTURAL CONCRETE
31 2	24-ULTRA HIGH PERFORMANCE STRUCTURAL CONCRETE
RT 1	GENERAL
	1.1 SUMMARY
	Structural members such as foundation walls, isolated footings, spread footing, columns, slabs, shaft walls, and stairs.
RT 2	PRODUCTS
	2.2 MANUFACTURES
	OLDCASTLE INC. Or equal
	2.3 DESCRIPTION
	Concrete must be 10,000 psi
	2.4 PERFORMANCE/DESIGN CRITERIA
	Must pass ASTM C39 / C39M-18 tests
	2.6 MATERIALS ASSEMBLY OR FABRICATION
	Mixed at plant
RT 3	. EXECUTION
	3.2 EXAMINATIONS
	Weather conditions must be permitting to pour. Must pass slump test when mix arrives to site.
	3.3 PREPERATIONS
	All form work must be checked before pour. Formwork surfaces must be clear of debris. Additionally, release agent must be applied to form work
	3.4 ERECTION/INSTALLATION/APPLICATION
	Verify all reinforcing members are correct. Pour concrete mix into molds. Vibrate formwork to release air pocket Cover formwork while curing to retain moisture in concrete. Allow 30 days to cure
49	00-GLASS FIBER REINFORCED CONCRETE
49 :	L6-GLASS FIBER REINFORCED CONCRETE SPANDRELS
RT 1	GENERAL
	1.1 SUMMARY
	Spandrel panels to be 1" thick, length and width are according to drawings. Additionally, vapor barriers to be applied to the back side of panel.
RT 2	PRODUCTS
	2.2 MANUFACTURES
	GFRC CLADDING
	2.4 PERFORMANCE/DESIGN CRITERIA

2.6 MATERIALS ASSEMBLY OR FABRICATION

Panels will be shop assembled


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2.7 MIXES AND FINISHES
                                                                                                                       Color must be dark grey, architect's approval for color will done after samples and mock ups. Finish will be
                                                                                                                       smooth.
                                                                                                              PART 3. EXECUTION
                                                                                                                       3.2 EXAMINATIONS
                                                                                                                        Panels will be tested to ensure they are to engineer's standards. Panels must be free of defects. Color must be
                                                                                                                        verified it is correct and not faded etc.
                                                                                                                       3.4 ERECTION/INSTALLATION/APPLICATION
                                                                                                                       Verify panel is up to standard. Place panel in curtain wall.
                                                                                                              DIVISION 05-METALS
                                                                                                              05 12 00-STRUCTURAL STEEL FRAMING
                                                                                                              05 12 33-STRUCTURAL STEEL FOR BUILDINGS
                                                                                                              PART 1. GENERAL
                                                                                                                       1.1 SUMMARY
                                                                                                                       Metal studs located in wall assemblies
                                                                                                              PART 2. PRODUCTS
                                                                                                                       2.2 MANUFACTURES
                                                                                                                       ClarkDietrich or equal
                                                                                                                       2.3 DESCRIPTION
                                                                                                                       2"x4" metal studs
                                                                                                                       4" Metal tracks
                                                                                                                       2.4 PERFORMANCE/DESIGN CRITERIA
                                                                                                                       Up to ASTM C745-18
                                                                                                                       2.6 MATERIALS ASSEMBLY OR FABRICATION
                                                                                                                       Manufacturer Fabricated
                                                                                                                       2.7 MIXES AND FINISHES
                                                                                                                       Standard CP60 coating
                                                                                                              PART 3. EXECUTION
                                                                                                                       3.2 EXAMINATIONS
                                                                                                                       Verify all members are correct sizes and lengts
                                                                                                                       3.4 ERECTION/INSTALLATION/APPLICATION
                                                                                                                        Layout bottom track on slab and secure to slab. Cut studs to appropriate lengths, then slide them into tracks. Keep
                                                                                                                        16" on center spacing for studs. Lastly slide top track on top of studs. Lastly secure track to bottom of slab. Verify
                                                                                                                       all members are secured and screwed appropriately.
                                                                                                              05 45 00-METAL SUPPORT ASSEMBLIES
                                                                                                              05 45 13-MECHANICAL METAL SUPPORTS
                                                                                                              PART 1. GENERAL
                                                                                                                       1.1 SUMMARY
                                                                                                                       Steel angles for curtain wall support
                                                                                                              PART 2. PRODUCTS
                                                                                                                       2.2 MANUFACTURES
                                                                                                                       Any capable mill
                                                                                                                       2.3 DESCRIPTION
                                                                                                                       5"x3"x1/4" A36 Steel Angle
                                                                                                                       2.4 PERFORMANCE/DESIGN CRITERIA
                                                                                                                       ASTM A36
                                                                                                                       2.6 MATERIALS ASSEMBLY OR FABRICATION
                                                                                                                       Shop Fabricated
                                                                                                                       2.7 MIXES AND FINISHES
                                                                                                                       Galvanized finish
                                                                                                              PART 3. EXECUTION
                                                                                                                       3.2 EXAMINATIONS
                                                                                                                        Verify angles are to specs shown on drawings.
                                                                                                                       3.4 ERECTION/INSTALLATION/APPLICATION
                                                                                                                        Verify steel angle is not deformed. Bolt 3" leg to Hilti HAC 70 cast in anchor. Bolt 5" leg to Kawneer vertical
                                                                                                                        mullion. . Torque bolts to engineers specifications. Mark bolts to verify it has been torqued.
                                                                                                              05 52 00-METAL RAILINGS
                                                                                                              05 52 13-PIPE AND TUBE RAILINGS
Must be able to deflect wind based upon engineer's calculations. Water must not be able to permeate through
                                                                                                              PART 1. GENERAL
                                                                                                                       1.1 SUMMARY
                                                                                                                       Railings for egress staircases
                                                                                                              PART 2. PRODUCTS
```



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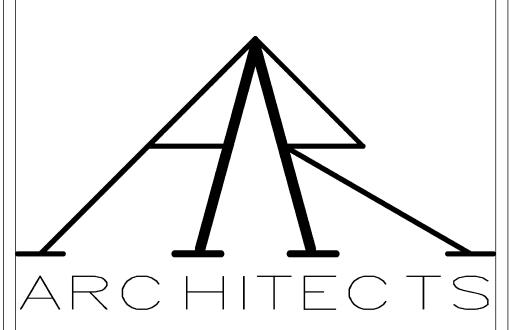
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2.4 PERFORMANCE/DESIGN CRITERIA




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Project
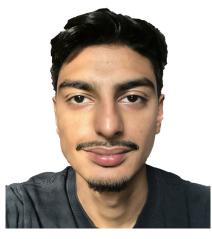
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RYAN SINGH

1 JOHN STREET

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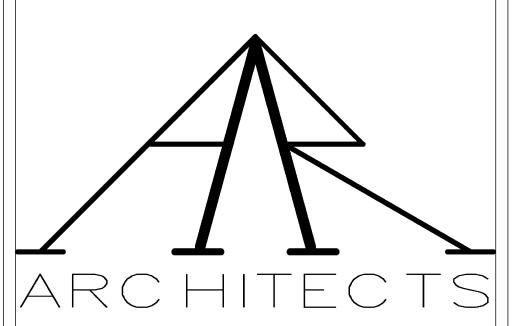
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ASTM D7832 compliant
                                                                                                                              Verify product is free of damage
                                                                                                                                                                                                                                                    7/8" Furring Hat Channel
PART 3. EXECUTION
                                                                                                                                                                                                                                                    2.4 PERFORMANCE/DESIGN CRITERIA
                                                                                                                              3.3 PREPERATIONS
                                                                                                                                                                                                                                                    ASTM A653/653M, ASTM A924/924M, ASTM A1003/A1003M, ASTM C645, and ASTM C754 Compliant
        3.2 EXAMINATIONS
                                                                                                                              Cover finished surfaces with plastic wrap
                                                                                                                                                                                                                                           PART 3. EXECUTION
        Verify membrane is free of punctures.
                                                                                                                              3.4 ERECTION/INSTALLATION/APPLICATION
        3.3 PREPERATIONS
                                                                                                                               Install based upon manufacturer's instructions
                                                                                                                                                                                                                                                    3.2 EXAMINATIONS
                                                                                                                                                                                                                                                    Verify furring's are correct size and free of damage
        Clear surfaces of debris
                                                                                                                      08 44 00-CURTAIN WALL AND GLAZED ASSEMBLIES
        3.4 ERECTION/INSTALLATION/APPLICATION
                                                                                                                                                                                                                                                    3.3 PREPERATIONS
                                                                                                                     08 44 13-GLAZED ALUMINUM CURTAIN WALLS
        Clear surfaces of debris. Start applying membrane from top of surfaces to the bottom. Be sure to overlap
                                                                                                                                                                                                                                                    Clear mounting surfaces of debris
                                                                                                                     PART 1. GENERAL
        membranes. After install inspect membranes are free of punctures and all surfaces covered.
                                                                                                                                                                                                                                                    3.4 ERECTION/INSTALLATION/APPLICATION
                                                                                                                              1.1 SUMMARY
07 90 00-JOINT PROTECTION
                                                                                                                                                                                                                                                    Screw furring into wall, verify furring is attached to wall properly. Space furring at 16" on center.
                                                                                                                              Curtain wall system utilized in project
07 91 23-BACKER RODS
                                                                                                                                                                                                                                           09 30 00-TILING
                                                                                                                     PART 2. PRODUCTS
PART 1. GENERAL
                                                                                                                              2.2 MANUFACTURES
                                                                                                                                                                                                                                           09 30 13-CERAMIC TILING
        1.1 SUMMARY
                                                                                                                                                                                                                                           PART 1. GENERAL
                                                                                                                               Kawneer
        Backer rod located at expansion joints.
                                                                                                                              2.3 DESCRIPTION
                                                                                                                                                                                                                                                    1.1 SUMMARY
PART 2. PRODUCTS
                                                                                                                              Kawneer 1600 Wall System 2 Curtain Wall
                                                                                                                                                                                                                                                    Ceramic tiles located in bathrooms
        2.2 MANUFACTURES
                                                                                                                              2.4 PERFORMANCE/DESIGN CRITERIA
                                                                                                                                                                                                                                           PART 2. PRODUCTS
        Sika or equal
                                                                                                                                                                                                                                                    2.2 MANUFACTURES
                                                                                                                               ASTM E1105-15 and ASTM E330/E330M-14 Compliant
        2.3 DESCRIPTION
                                                                                                                              2.6 MATERIALS ASSEMBLY OR FABRICATION
                                                                                                                                                                                                                                                    Ceramic Tile Works or equal
        3/4" Closed cell backer rod
                                                                                                                              Assembled on site
                                                                                                                                                                                                                                                    2.3 DESCRIPTION
        2.4 PERFORMANCE/DESIGN CRITERIA
                                                                                                                              2.7 MIXES AND FINISHES
                                                                                                                                                                                                                                                    10"x16",13"x13" Cove Ceramic tile
        ASTM D5249 Compliant
                                                                                                                               Flat aluminum finish
                                                                                                                                                                                                                                                    2.7 MIXES AND FINISHES
PART 3. EXECUTION
                                                                                                                     PART 3. EXECUTION
                                                                                                                                                                                                                                                    Ice Finish
         3.3 PREPERATIONS
                                                                                                                              3.2 EXAMINATIONS
                                                                                                                                                                                                                                           PART 3. EXECUTION
        Clear joint of debris
                                                                                                                              Verify correct members are used in appropriate locations
                                                                                                                                                                                                                                                    3.2 EXAMINATIONS
         3.4 ERECTION/INSTALLATION/APPLICATION
                                                                                                                              3.3 PREPERATIONS
                                                                                                                                                                                                                                                    Verify tiles are not cracked and are correct size
        Push backer rod ½" to 1" into joint. Verify baker rod is secure.
                                                                                                                              Clear area of debris. Verify anchors are correctly torques. All finished surfaces and Glass lites are to be covered.
                                                                                                                                                                                                                                                    3.3 PREPERATIONS
<u>07 92 00-JOINT SEALANT</u>
                                                                                                                              3.4 ERECTION/INSTALLATION/APPLICATION
                                                                                                                                                                                                                                                    Clear work area of debris
07 92 13-ELASTOMETRIC JOINT SEALERS
                                                                                                                              Start assembling system from bottom to top. Assemble components according to manufacturer's instructions.
                                                                                                                                                                                                                                                    3.4 ERECTION/INSTALLATION/APPLICATION
PART 1. GENERAL
                                                                                                                                                                                                                                                    Layout tiles according, cut tiles at edges if necessary. Apply thin set mortar to floor. Place tile on floor with
                                                                                                                      08 91 00-LOUVERS
                                                                                                                                                                                                                                                    spacers. Adjust tiles so they are leveled. Allow mortar to dry and remove spacers. Apply layer of grout over joints
        1.1 SUMMARY
                                                                                                                     08 91 19-FIXED LOUVERS
                                                                                                                                                                                                                                                    and wipe away excess grout. After grout dries clean all tiles.
        Sealant located at joints.
                                                                                                                      PART 1. GENERAL
                                                                                                                                                                                                                                           09 30 33-STONE TILING
PART 2. PRODUCTS
                                                                                                                              1.1 SUMMARY
                                                                                                                                                                                                                                           PART 1. GENERAL
         2.2 MANUFACTURES
                                                                                                                               Louvers located at exterior walls of mechanical rooms
                                                                                                                                                                                                                                                    1.1 SUMMARY
         Sika
                                                                                                                     PART 2. PRODUCTS
                                                                                                                                                                                                                                                    Marble located at lobbies
        2.3 DESCRIPTION
                                                                                                                              2.2 MANUFACTURES
                                                                                                                                                                                                                                           PART 2. PRODUCTS
         Sikasil N Plus US
                                                                                                                              Greenheck
                                                                                                                                                                                                                                                    2.2 MANUFACTURES
        2.4 PERFORMANCE/DESIGN CRITERIA
                                                                                                                              2.3 DESCRIPTION
                                                                                                                                                                                                                                                    Ceramic Tile Works or equal
        ASTM C920 Compliant
                                                                                                                              ESD-435
                                                                                                                                                                                                                                                   2.3 DESCRIPTION
PART 3. EXECUTION
                                                                                                                              2.4 PERFORMANCE/DESIGN CRITERIA
                                                                                                                                                                                                                                                    24"x24" Venatino marble
        3.3 PREPERATIONS
                                                                                                                               AMCA 500-L Water Penetration and air performance compliant.
                                                                                                                                                                                                                                                    2.7 MIXES AND FINISHES
        Clear joint of debris
                                                                                                                              2.6 MATERIALS ASSEMBLY OR FABRICATION
                                                                                                                                                                                                                                                    Venatino Bianco
        3.4 ERECTION/INSTALLATION/APPLICATION
                                                                                                                              Factory assembled
                                                                                                                                                                                                                                           PART 3. EXECUTION
        Verify backer rod is placed in joint. Lay sealant into joint. After, with plastic sealant tool smoothen the sealant
                                                                                                                              2.7 MIXES AND FINISHES
                                                                                                                                                                                                                                                    3.2 EXAMINATIONS
DIVISION 08-OPENINGS
                                                                                                                               Aluminum finish
                                                                                                                                                                                                                                                    Verify tiles are not cracked and are correct size
08 13 00-METAL DOORS
                                                                                                                     PART 3. EXECUTION
                                                                                                                                                                                                                                                    3.3 PREPERATIONS
                                                                                                                              3.2 EXAMINATIONS
08 13 13-HOLLOW METAL DOORS
                                                                                                                                                                                                                                                    Clear work area of debris
                                                                                                                              Verify products are free of defects
                                                                                                                                                                                                                                                    3.4 ERECTION/INSTALLATION/APPLICATION
PART 1. GENERAL
                                                                                                                              3.3 PREPERATIONS
                                                                                                                                                                                                                                                    Layout tiles according, cut tiles at edges if necessary. Apply thin set mortar to floor. Place tile on floor with
        1.1 SUMMARY
                                                                                                                                                                                                                                                    spacers. Adjust tiles so they are leveled. Allow mortar to dry and remove spacers. Apply layer of grout over joints
                                                                                                                              Clear area of debris.
        Hollow metal doors located at exteriors and interiors
                                                                                                                                                                                                                                                    and wipe away excess grout. After grout dries clean all tiles.
                                                                                                                              3.4 ERECTION/INSTALLATION/APPLICATION
PART 2. PRODUCTS
                                                                                                                                                                                                                                           09 51 00-ACOUSTICAL CIELINGS
                                                                                                                              Install louver according to manufacturer's instructions.
        2.2 MANUFACTURES
                                                                                                                                                                                                                                           09 51 13-ACOUSTICAL PANEL CIELINGS
        Curries or equal
                                                                                                                     DIVISION 09-FINISHES
                                                                                                                                                                                                                                           PART 1. GENERAL
        2.3 DESCRIPTION
                                                                                                                     09 22 00-SUPPORT FOR PLASTER AND GYPSUM BOARD
                                                                                                                                                                                                                                                   1.1 SUMMARY
        Exterior-36"x84"x7' 747 Series-steel stiffened
                                                                                                                                                                                                                                                    Acoustic Ceiling
                                                                                                                     09 22 13-METAL FURRING
        Interior- 36"x84"x7' 607 Series-composite
                                                                                                                                                                                                                                           PART 2. PRODUCTS
                                                                                                                      PART 1. GENERAL
        2.4 PERFORMANCE/DESIGN CRITERIA
                                                                                                                                                                                                                                                    2.2 MANUFACTURES
                                                                                                                              1.1 SUMMARY
        3 hour fire rated
                                                                                                                                                                                                                                                    Armstrong
                                                                                                                              Furring channels
        2.7 MIXES AND FINISHES
                                                                                                                                                                                                                                                    2.3 DESCRIPTION
                                                                                                                     PART 2. PRODUCTS
        Stainless Steel
                                                                                                                                                                                                                                                    Clean Room VL-2'x2' Panel
                                                                                                                              2.2 MANUFACTURES
PART 3. EXECUTION
                                                                                                                                                                                                                                                    2.4 PERFORMANCE/DESIGN CRITERIA
                                                                                                                              Cemcostal or equal
        3.2 EXAMINATIONS
                                                                                                                                                                                                                                                    ASTM E84 Compliant
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2.3 DESCRIPTION

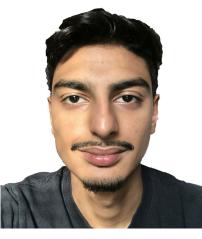


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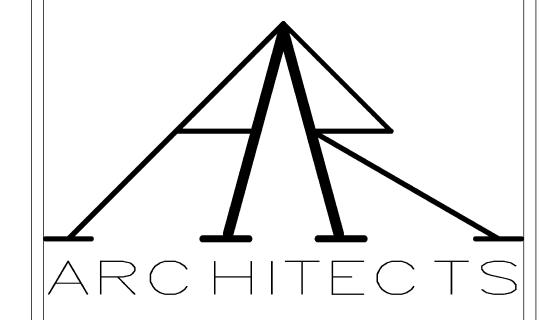
AQIB BHATTI

1 JOHN STREET

OUTLINE SPECIFICATIONS

	Project Number	Project Number
	Date	Issue Date
	Drawn By	AQIB BHATTI
	Checked By	Checker

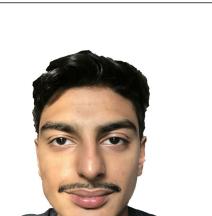A-600.02



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1 JOHN STREET

OUTLINE SPECIFICATIONS

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Verify position of fixture is ADA compliant (refer to drawing G-101.00). Install based upon manufacturers supplied
        2.7 MIXES AND FINISHES
                                                                                                                               instructions. Once installed verify fixture is properly working and free of leaks. After installation is complete, clear
         #8 Stainless steel finish
                                                                                                                               area of debris and clean fixture.
PART 3. EXECUTION
                                                                                                                      22 42 13.16-COMMERCIAL URINALS
        3.2 EXAMINATIONS
                                                                                                                      PART 1. GENERAL
        Verify all components and assemblies are complete
                                                                                                                               1.1 SUMMARY
        3.3 PREPERATIONS
                                                                                                                               Urinals in bathrooms
        During installation and testing install elevator pads
                                                                                                                      PART 2. PRODUCTS
        3.4 ERECTION/INSTALLATION/APPLICATION
                                                                                                                               2.2 MANUFACTURES
        Install based upon manufacturers instruction
                                                                                                                               KOHLER
DIVISION 21-FIRE SUPPRESION
                                                                                                                               2.3 DESCRIPTION
                                                                                                                               Stanwell blow out 0.5-1.0 urinal with rear spud
21 13 00-FIRE SUPPRESION SPRINKLER SYSTEM
                                                                                                                               2.4 PERFORMANCE/DESIGN CRITERIA
21 13 16-DRY PIPE SPRINKLER SYSTEM
                                                                                                                              Certified by IAPMO R&T
PART 1. GENERAL
                                                                                                                               ADA compliant
        1.1 SUMMARY
                                                                                                                               2.6 MATERIALS ASSEMBLY OR FABRICATION
        Sprinkler heads
                                                                                                                               Factory assembled
PART 2. PRODUCTS
                                                                                                                               2.7 MIXES AND FINISHES
        2.2 MANUFACTURES
                                                                                                                               Standard white
        VIKING
                                                                                                                      PART 3. EXECUTION
        2.3 DESCRIPTION
                                                                                                                               3.2 EXAMINATIONS
         VK003-Micromatic Standard response pendent sprinkler
                                                                                                                               Verify product is free of defects and cracks
        2.4 PERFORMANCE/DESIGN CRITERIA
                                                                                                                               3.3 PREPERATIONS
        FM Certificate of compliance
                                                                                                                               Clean area of debris and cover finished surfaces
        2.6 MATERIALS ASSEMBLY OR FABRICATION
                                                                                                                               3.4 ERECTION/INSTALLATION/APPLICATION
         Manufacture assembled
                                                                                                                               Verify position of fixture is ADA compliant (refer to drawing G-101.00). Install based upon manufacturers supplied
        2.7 MIXES AND FINISHES
                                                                                                                               instructions. Once installed verify fixture is properly working and free of leaks. After installation is complete, clear
                                                                                                                               area of debris and clean fixture.
        Chrome finish
                                                                                                                      22 42 16.16-COMMERCIAL SINKS
                                                                                                                      PART 1. GENERAL
PART 3. EXECUTION
                                                                                                                               1.1 SUMMARY
        3.2 EXAMINATIONS
                                                                                                                               Sinks in bathrooms
        Verify plumbing system and fittings are correctly installed
                                                                                                                      PART 2. PRODUCTS
        3.3 PREPERATIONS
                                                                                                                               2.2 MANUFACTURES
        Cut appropriate size hole in act panel
                                                                                                                               KOHLER
        3.4 ERECTION/INSTALLATION/APPLICATION
                                                                                                                               2.3 DESCRIPTION
         Locate sprinkler location. Install attachment cables. Cut hole in act panel. Install sprinkler head to plumbing and
         suspension cable. Guide sprinkler head through hole in act panel. Install act panel in track. Screw bezel to secure
                                                                                                                              Chesapeake 19-1/4" x 17-1/4" wall mounted/concealed carrier arm bathroom sink with 4" center set faucet holes
        sprinkler head to act panel
                                                                                                                               2.4 PERFORMANCE/DESIGN CRITERIA
DIVISION 22-PLUMBING
                                                                                                                               ADA compliant
22 42 16-COMMERCIAL PLUMBING
                                                                                                                               2.6 MATERIALS ASSEMBLY OR FABRICATION
22 42 13.13-COMMERCIAL WATER CLOSETS
                                                                                                                               Factory assembled
PART 1. GENERAL
                                                                                                                               2.7 MIXES AND FINISHES
        1.1 SUMMARY
                                                                                                                               Standard white
         Water closets in bathrooms
                                                                                                                      PART 3. EXECUTION
PART 2. PRODUCTS
                                                                                                                               3.2 EXAMINATIONS
         2.2 MANUFACTURES
                                                                                                                               Verify product is free of defects and cracks
        KOHLER
                                                                                                                               3.3 PREPERATIONS
        2.3 DESCRIPTION
                                                                                                                               Clean area of debris and cover finished surfaces
        Kingston wall mounted 1.6 gpf flushometer valve toilet bowl with top inlet
                                                                                                                               3.4 ERECTION/INSTALLATION/APPLICATION
        2.4 PERFORMANCE/DESIGN CRITERIA
                                                                                                                               Verify position of fixture is ADA compliant (refer to drawing G-101.00). Install based upon manufacturers supplied
                                                                                                                               instructions. Once installed verify fixture is properly working and free of leaks. After installation is complete, clear
        Certified by IAPMO R&T
                                                                                                                               area of debris and clean fixture.
        ADA compliant
                                                                                                                      DIVISION 23-HEATING, VENTILATING, AND AIR CONDITIONING (HVAC)
        2.6 MATERIALS ASSEMBLY OR FABRICATION
                                                                                                                      23 37 00-AIR OUTLETS AND INLETS
        Factory assembled
                                                                                                                      23 37 13-DIFFUSERS, REGISTERS AND GRILLES
        2.7 MIXES AND FINISHES
                                                                                                                      PART 1. GENERAL
         Standard white
                                                                                                                               1.1 SUMMARY
PART 3. EXECUTION
                                                                                                                              Diffusers located in ceiling
         3.2 EXAMINATIONS
                                                                                                                      PART 2. PRODUCTS
        Verify product is free of defects and cracks
                                                                                                                               2.2 MANUFACTURES
        3.3 PREPERATIONS
                                                                                                                               Manufactured Duct & Supply
         Clean area of debris and cover finished surfaces
                                                                                                                              Or equal
        3.4 ERECTION/INSTALLATION/APPLICATION
                                                                                                                               2.3 DESCRIPTION
```

6"-24"x24" Louvered Diffuser

2.4 PERFORMANCE/DESIGN CRITERIA ASTM F2975 Standards 2.6 MATERIALS ASSEMBLY OR FABRICATION Factory assembled 2.7 MIXES AND FINISHES White Finish PART 3. EXECUTION 3.2 EXAMINATIONS Verify diffuser is not damaged 3.3 PREPERATIONS Clean diffuser after installation 3.4 ERECTION/INSTALLATION/APPLICATION Place diffuser in specified location in ceiling tracks. Connect duct to diffuser. Place all panels in respected locations. Clean diffuser of any debris. **DIVISION 26-ELECTRICAL** 26 51 00-INTERIOR LIGHTING 26 51 16-FUORESCENT INTERIOR LIGHTING PART 1. GENERAL 1.1 SUMMARY All lighting accessories PART 2. PRODUCTS 2.2 MANUFACTURES Cooper Industries or equal 2.3 DESCRIPTION Class R2 Micro Baffle 1T5 2x2 LDB6 Downlight 2.4 PERFORMANCE/DESIGN CRITERIA ASTM E1733-95 2.6 MATERIALS ASSEMBLY OR FABRICATION Factory assembled 2.7 MIXES AND FINISHES Standard white finish for Class R2 Micro Baffle Stainless Steel for LDB6 PART 3. EXECUTION 3.2 EXAMINATIONS Verify fixtures are free of defects 3.3 PREPERATIONS Protect surfaces before installation 3.4 ERECTION/INSTALLATION/APPLICATION Verify electricity is cut off. Depending on fixture cut hole in ceiling. Attach wires according to manufacturer. Insert fixture into ceiling and lock in with bezel. Turn power on and test light fixture is working. Clean fixture after installation is complete




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OUTLINE SPECIFICATIONS

Project Number

Date

Drawn By
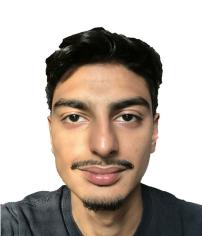
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Project Number

Issue Date

AQIB BHATTI

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Finish Schedule							
Level	Room Name	Room Number	Floor Area	Wall Finish	Base Finish	Floor Finish	Ceiling Finish
GROUND FLOOR	BATH RM. 1	G01	70 SF	PAINTED/TILE	TILE	Tile, Porcelain, 4in	GYP
GROUND FLOOR	BATH RM. 2	G02	70 SF	PAINTED/TILE	TILE	Tile, Porcelain, 4in	GYP
GROUND FLOOR	BLDG OFFICE	G03	113 SF	PAINTED	VINYL	Carpet (1)	ACT
GROUND FLOOR	BLDG. OFFICE	G04	113 SF	PAINTED	VINYL	Carpet (1)	ACT
GROUND FLOOR	BLDG. STORAGE	G05	114 SF	PAINTED	VINYL	Concrete, Cast-in-Place gray	U.F.
GROUND FLOOR	MECH. ROOM 1	G06	351 SF	PAINTED	N.A	Concrete, Cast-in-Place gray	U.F.
GROUND FLOOR	ELEVATOR SHAFT 2	G07	270 SF	U.F.	N.A	Concrete, Cast-in-Place gray	U.F.
GROUND FLOOR	JANITOR CLOSET 1	G08	55 SF	PAINTED	N.A	Concrete, Cast-in-Place gray	U.F.
GROUND FLOOR	JANITOR CLOSET 2	G09	55 SF	PAINTED	N.A	Concrete, Cast-in-Place gray	U.F.
GROUND FLOOR	OFFICE LOBBY	G10	478 SF	MARBLE	MARBLE	Marble	GYP
GROUND FLOOR	ELEVATOR SHAFT 2	G11	283 SF	U.F.	N.A	Concrete, Cast-in-Place, Gray	U.F.
GROUND FLOOR	OPEN FLOOR 1	G12	2798 SF	PAINTED	VINYL	Vinyl Composition Tile	ACT
GROUND FLOOR	MECH ROOM 2	G13	356 SF	U.F.	N.A	Concrete, Cast-in-Place, Gray	U.F.
GROUND FLOOR	OPEN FLOOR 2	G14	2806 SF	PAINTED	VINYL	Vinyl Composition Tile	ACT
GROUND FLOOR	SHAFT 2	G15	63 SF	U.F.	N.A	Concrete, Cast-in-Place, Gray	U.F.
GROUND FLOOR	SHAFT 1	G16	74 SF	U.F.	N.A	Concrete, Cast-in-Place, Gray	U.F.
GROUND FLOOR	STAIR 1	G17	212 SF	PAINTED	VINYL	Concrete, Cast-in-Place, Gray	U.F.
GROUND FLOOR	STAIRS 2	G18	197 SF	PAINTED	VINYL	Concrete, Cast-in-Place, Gray	U.F.
GROUND FLOOR	HALLWAY 1	G19	126 SF	PAINTED	VINYL	Carpet (1)	ACT
THIRD FLOOR	OFFICE	300	199 SF	PAINTED	VINYL	Carpet (1)	ACT
THIRD FLOOR	OFFICE	301	204 SF	PAINTED	VINYL	Carpet (1)	ACT
THIRD FLOOR	COAT ROOM	302	3236 SF	PAINTED	VINYL	Vinyl Composition Tile	ACT
THIRD FLOOR	OFFICE	303	150 SF	PAINTED	VINYL	Carpet (1)	ACT
THIRD FLOOR	OFFICE	304	150 SF	PAINTED	VINYL	Carpet (1)	ACT
THIRD FLOOR	OFFICE	305	150 SF	PAINTED	VINYL	Carpet (1)	ACT
THIRD FLOOR	OFFICE	306	150 SF	PAINTED	VINYL	Carpet (1)	ACT
THIRD FLOOR	OFFICE	307	150 SF	PAINTED	VINYL	Carpet (1)	ACT
THIRD FLOOR	OFFICE	308	150 SF	PAINTED	VINYL	Carpet (1)	ACT
THIRD FLOOR	OFFICE	309	216 SF	PAINTED	VINYL	Carpet (1)	ACT
THIRD FLOOR	OFFICE	310	213 SF	PAINTED	VINYL	Carpet (1)	ACT
THIRD FLOOR	STAFF LOUNGE	311	483 SF	PAINTED	VINYL	Carpet (1)	GYP
THIRD FLOOR	CON. ROOM	312	261 SF	MARBLE	MARBLE	Marble	GYP
THIRD FLOOR	CON. ROOM	313	240 SF	MARBLE	MARBLE	Marble	GYP
THIRD FLOOR	CON. ROOM	314	239 SF	MARBLE	MARBLE	Marble	GYP
THIRD FLOOR	CON. ROOM	315	245 SF	MARBLE	MARBLE	Marble	GYP
THIRD FLOOR	WOMENS BATHROOM	319	191 SF	PAINTED/TILE	TILE	Tile, Porcelain, 4in	GYP
THIRD FLOOR	MENS BATHROOM	320	193 SF	PAINTED/TILE	TILE	Tile, Porcelain, 4in	GYP
THIRD FLOOR	MECH. ROOM	322	514 SF	U.F.	N.A	Concrete, Cast-in-Place, Gray	U.F.
THIRD FLOOR	STORAGE	323	105 SF	PAINTED	N.A	Concrete, Cast-in-Place, Gray	GYP
THIRD FLOOR	STORAGE	324	105 SF	PAINTED	N.A	Concrete, Cast-in-Place, Gray Concrete, Cast-in-Place, Gray	GYP
THIRD FLOOR	E.L ROOM	325	18 SF	PAINTED	N.A	Concrete, Cast-in-Place, Gray Concrete, Cast-in-Place, Gray	U.F.
THIRD FLOOR	J.C	328	48 SF	PAINTED	11./7	Concrete, Cast-in-Place, Gray Concrete, Cast-in-Place, Gray	U.F.



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FINISH PLAN SCHEDULE

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